

ADMINISTRATIVE AMENDMENT
 File # 05-00314 Project # 1001445
 Stockroom Expansion
 DATE 4/5/05
 Approved by [Signature]

1001445




- LEGEND**
- EXISTING SAS MANHOLE
 - EX. 8" SWS --- EXISTING SANITARY SEWER LINE
 - ⊗ EXISTING VALVE W/BOX
 - ⊕ EXISTING FIRE HYDRANT
 - EX. 16" W. --- EXISTING WATER LINE
 - ⊙ EXISTING STORM SEWER MANHOLE
 - EX. 24" RCP --- EXISTING STORM SEWER INLET
 - EX. 24" RCP --- EXISTING STORM SEWER LINE
 - EXISTING FENCE
 - EXISTING CURB & GUTTER
 - EXISTING BOUNDARY LINE
 - EASEMENT
 - EXISTING SIDEWALK
 - 50.11 --- EXISTING CONTOUR
 - 50.10 --- EXISTING INDEX CONTOUR
 - x 5048.25 --- EXISTING SPOT ELEVATION
 - CENTERLINE
 - RIGHT-OF-WAY
 - GRADE BREAK



ENGINEER'S SEAL RONALD R. BOHANNAN REGISTERED PROFESSIONAL ENGINEER NO. 146618 STATE OF NEW MEXICO	WAL-MART #1397 STOCKROOM ADDITION
DATE 03-01-05	OVERALL SITE PLAN
DRAWN BY EMT	2485-09B-12-13-04
SHEET # C105	JOB # 24095
TERRA WEST, LLC 8509 JEFFERSON NE ALBUQUERQUE, NEW MEXICO 87113 (505)858-3100	02-09-05 PERMIT ISSUE


EXISTING WAL-MART

SUPER CENTER #1397
 GROSS S.F. = 210,187
 FINISHED FLOOR ELEV. 5050.78

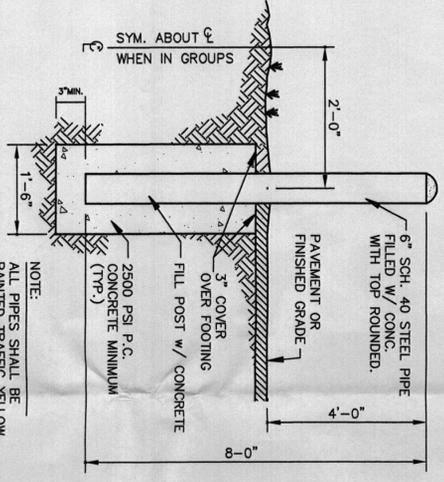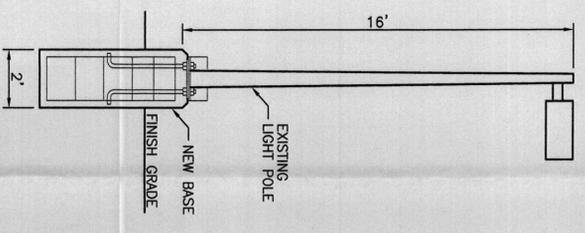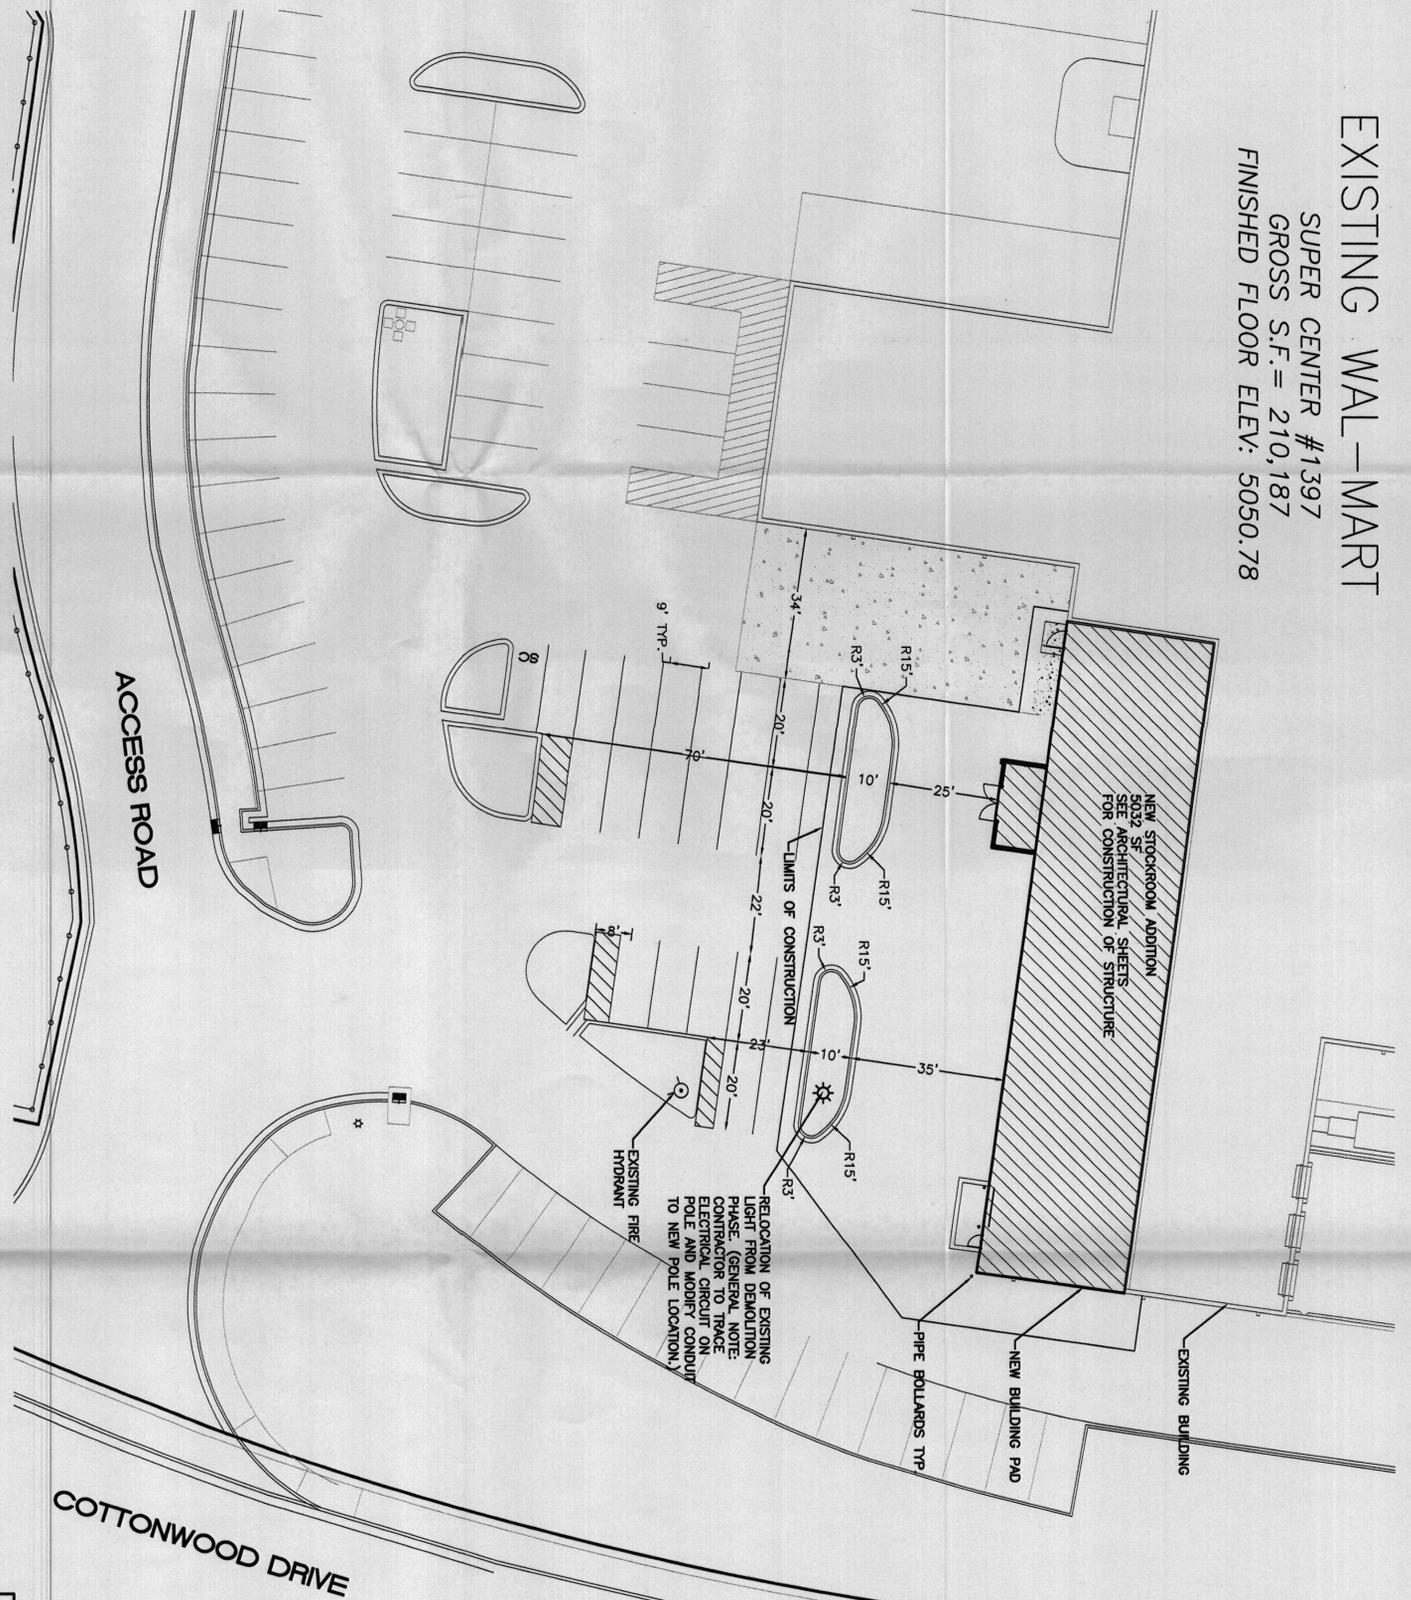

LEGEND

- EXISTING SWS MANHOLE
- EX. 8" SWS --- EXISTING SANITARY SEWER LINE
- EX. 16" W. --- EXISTING WATER LINE
- EX. 24" ROP --- EXISTING STORM SEWER INLET
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- EX. 16" ROP --- EXISTING FENCE
- EX. CURB & GUTTER
- EXISTING BOUNDARY LINE
- EASEMENT
- EXISTING SIDEWALK
- EXISTING CONTOUR
- EXISTING INDEX CONTOUR
- EXISTING SPOT ELEVATION
- CENTERLINE
- RIGHT-OF-WAY
- GRADE BREAK

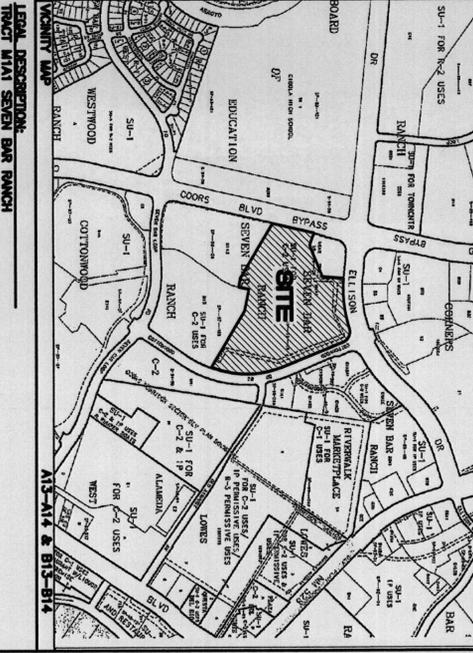

SITE DATA

PROPOSED USAGE:	GENERAL RETAIL USE
LOT AREA:	783,749 SF (17.9923 ACRES)
STOCKROOM AREA:	210,187 SF
STOCKROOM EXPANSION AREA:	5,032 SF
PARKING PROVIDED (INCLUDING EMPLOYEE):	938 SPACES
PARKING REQUIRED:	756 SPACES
HC PARKING PROVIDED:	25 SPACES (INCLUDING 3 VAN ACCESSIBLE)
HC PARKING REQUIRED:	21 SPACES



PROJECT NUMBER: _____
APPLICATION NUMBER: _____

This plan is consistent with the specific Site Development Plan approved by the Environmental Planning Commission (EPC), dated _____, and the Findings and Conditions in the Official Resolution of Decision are satisfied.

Is an Infrastructure List required? () Yes () No. If Yes, then a set of approved DDC plans with a work order is required for any construction within public right-of-way or for consideration of public improvement.

DRB SITE DEVELOPMENT PLAN SIGNOFF APPROVAL:

Traffic Engineer, Transportation Division	Date
Utilities Development	Date
Parks & Recreation Department	Date
City Engineer	Date
* Environmental Health Department (conditional)	Date
Solid Waste Management	Date
DRB Chairperson, Planning Department	Date

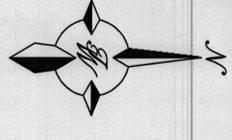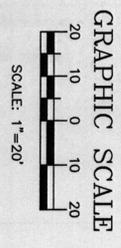


02-09-05
PERMIT ISSUE

ENGINEER'S SEAL	DATE
WAL-MART #1397 STOCKROOM ADDITION	03-01-05
SITE PLAN FOR BUILDING PERMIT	2485-07B-12-13-04
SHEET #	C106
JOB #	24085

TERRA WEST, LLC
 8509 JEFFERSON NE
 ALBUQUERQUE, NEW MEXICO 87113
 (505) 858-3100

ENGINEER R. BOHANNAN
 P.E. #7868

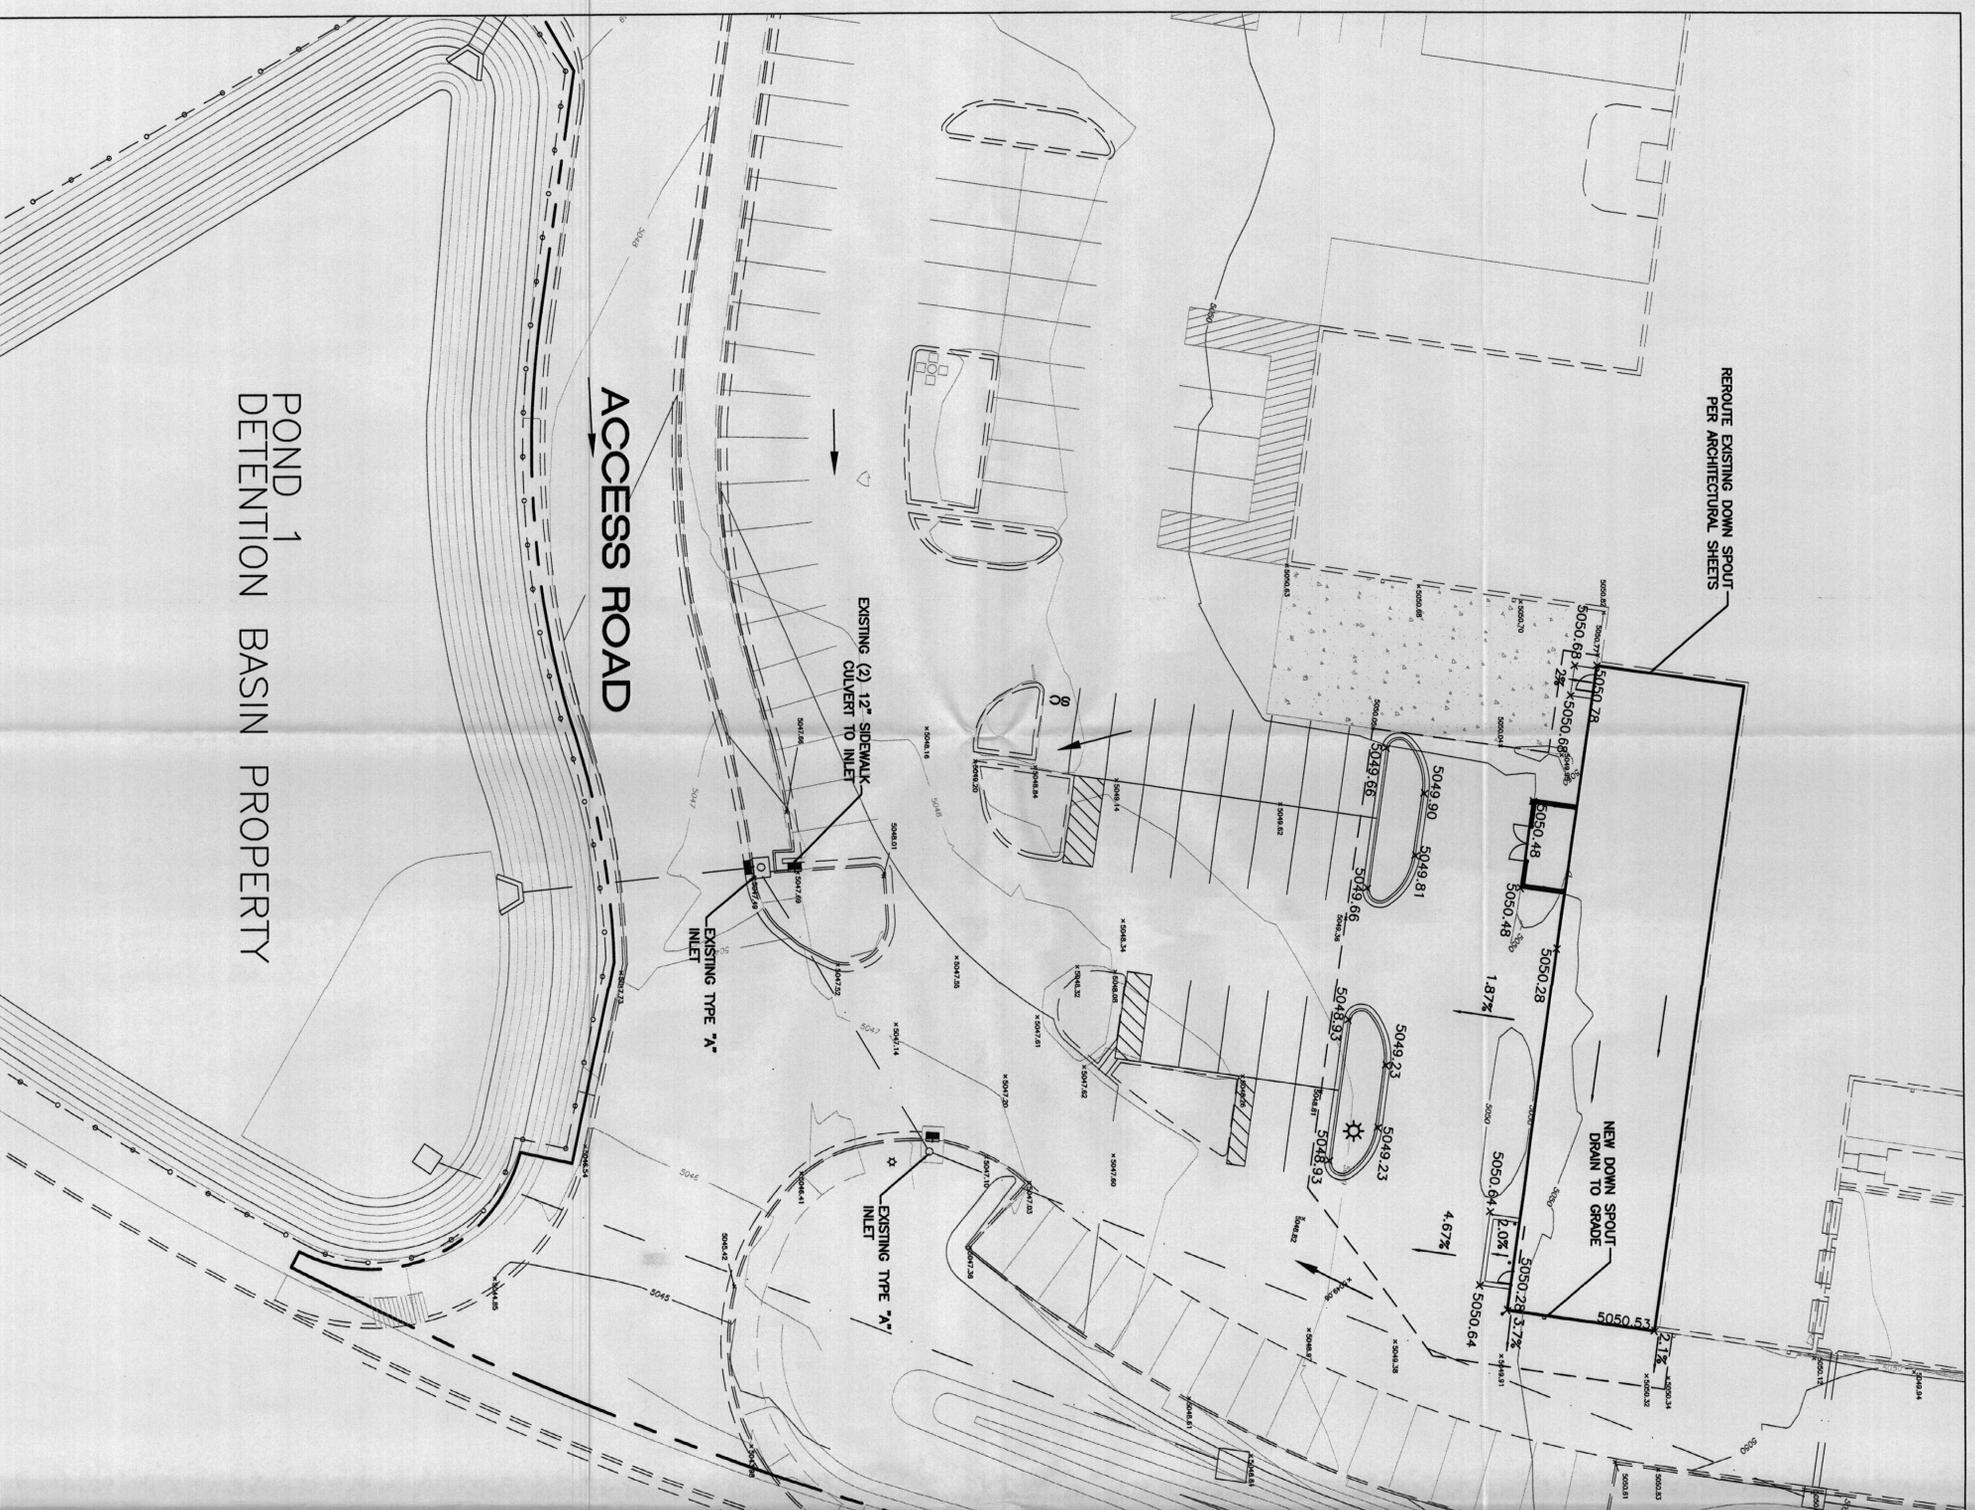

ROUTINE EXISTING DOWN SPOUT PER ARCHITECTURAL SHEETS

NEW DOWN SPOUT DRAIN TO GRADE

ACCESS ROAD

POND 1
DETENTION BASIN PROPERTY

COTTONWOOD DR.

FOUNDATION SURFACE PREPARATION PROPOSED STOCKROOM ADDITION EXISTING WAL-MART STORE #1397 SOUTHWEST QUADRANT OF COORS BOULEVARD BYPASS AND ELLISON DRIVE TERRA WEST, LLC PROJECT NO. 06055004 02/07/05

UNLESS SPECIFICALLY INDICATED OTHERWISE IN THE DRAWINGS AND/OR SPECIFICATIONS, THE LIMITS OF THIS SURFACE PREPARATION ARE CONSIDERED TO BE THAT PORTION OF THE SITE DIRECTLY BENEATH AND 10 FEET BEYOND THE BUILDING ADDITION AND APURTAINANCES.

APURTAINANCES ARE THOSE ITEMS ATTACHED TO THE BUILDING PROPER (REFER TO DRAWING SHEET SP-1), TYPICALLY INCLUDING, BUT NOT LIMITED TO, THE BUILDING SIDEWALKS, PORCHES, RAMPS, AND STAIRS. THE SUBBASE AND THE VAPOR BARRIER, WHERE REQUIRED, DO NOT EXTEND BEYOND THE LIMITS OF THE ACTUAL BUILDING ADDITION AND THE APURTAINANCES.

ESTABLISH THE FINAL SUBGRADE ELEVATION TO ALLOW FOR THE SLAB THICKNESS AND A 6 INCH SUBBASE FOR EXPOSED CONCRETE SLABS CONSISTING OF 4 INCH COARSE AGGREGATE AND 2 INCH FINE AGGREGATE. THE INTERIOR SLAB SUBBASE SHALL CONSIST OF 4 INCHES OF COARSE AGGREGATE MEETING THE GRADATION REQUIREMENTS OF OPEN GRADED AGGREGATE (ASTM D-448) AND 2 INCHES OF FINE AGGREGATE MEETING THE GRADATION REQUIREMENTS OF OPEN GRADED AGGREGATE (ASTM D-448). THE EXTERIOR SLAB SUBBASE SHALL CONSIST OF 4 INCHES OF COARSE AGGREGATE MEETING THE GRADATION REQUIREMENT OF 089C AS DEFINED BY MNDOT, SECTION 304 COVERED WITH 2 INCHES OF FINE AGGREGATE MEETING THE GRADATION REQUIREMENTS OF ASTM D-448. SIZE 10 AGGREGATE WITH 6 PERCENT TO 12 PERCENT PASSING THE NO. 200 SIEVE D-448. SIZE 10 AGGREGATE WITH 6 PERCENT TO 12 PERCENT ACCURATE MEASUREMENTS FOR ALL CUT AND FILL DERIVS REQUIRED.

REMOVE EXISTING ASPHALT AND DELETERIOUS MATERIALS, ETC., FROM THE BUILDING ADDITION AREA UPON REMOVAL OF SURFACE MATERIALS. EXISTING SOILS SHOULD BE REMOVED WITHIN THE LIMITS OF THE FOOTINGS AND SLAB AND 32 INCHES BEYOND THE OUTSIDE EDGE OF PERIMETER FOOTINGS. UPON REMOVAL OF THE EXISTING SOILS, THE SPREAD FOUNDATIONS SHOULD BEAR ON A MINIMUM OF 4 FEET OF ENGINEERED FILL AND THE INTERIOR SLABS SHOULD BEAR ON A MINIMUM OF 2 FEET OF ENGINEERED FILL. PROTECT ALL EXPOSED SUBGRADE WITH SUITABLE MATERIAL AND ENGINEERED FILL. MATERIAL SHALL BE FREE OF ORGANIC AND OTHER DELETERIOUS MATERIALS AND SHALL MEET THE FOLLOWING REQUIREMENTS:

- 1. MAX. PARTICLE SIZE (ASTM C136) 12 MAX. 35 MAX.
- 2. MAX. CLAY CONTENT (ASTM D2922) 15 MAX. 11 MAX.
- 3. MAX. PLASTICITY INDEX (ASTM D2922) 100 50 (from 50-100)
- 4. MAX. LIQUIDITY LIMIT (ASTM D2922) 50 (from 50-100)

THE SUBGRADE MATERIAL SHALL BE PLACED IN LOOSE LIFTS NOT EXCEEDING 10 INCHES IN THICKNESS. IF SOIL HAS NO PI AND 8 INCHES FOR SOILS WITH PI AND COMPACTED TO AT LEAST 95 PERCENT OF THE MODIFIED PROCTOR MAXIMUM DRY DENSITY (ASTM D1557) AT A MOISTURE CONTENT WITHIN 1 PERCENT BELOW TO 3 PERCENT ABOVE THE OPTIMUM FOR SOILS WITH A PLASTICITY INDEX GREATER THAN 5 AND AT A MOISTURE CONTENT WITHIN 3 PERCENT BELOW TO OPTIMUM FOR ALL OTHER SOILS. THE CONTRACTOR SHOULD ACKNOWLEDGE BOTH COMPACTION AND SOIL MOISTURE ENGINEERED FILL REQUIREMENTS MUST BE MET TO ACHIEVE A SUITABLE ENGINEERED FILL.


THE FOUNDATION SYSTEM SHALL BE ISOLATED SPREAD FOOTINGS AT COLUMNS AND CONTINUOUS SPREAD FOOTINGS AT WALLS.

THIS FOUNDATION SURFACE PREPARATION DOES NOT CONSTITUTE A COMPLETE SITE WORK SPECIFICATION. IN CASE OF CONFLICT, INFORMATION COVERED IN THIS PREPARATION SHALL TAKE PRECEDENCE OVER THE WAL-MART SPECIFICATION. REFER TO THE SPECIFICATIONS FOR SPECIFIC INFORMATION NOT COVERED IN THIS PREPARATION. THIS INFORMATION WAS TAKEN FROM A GEOTECHNICAL REPORT PREPARED BY TERRACON, DATED FEBRUARY 1, 2005. (GEOTECHNICAL REPORT IS FOR INFORMATION ONLY AND IS NOT A CONSTRUCTION SPECIFICATION).

EROSION CONTROL NOTES


1. CONTRACTOR IS RESPONSIBLE FOR OBTAINING A TOPSOIL DISTURBANCE PERMIT PRIOR TO BEGINNING WORK.
2. CONTRACTOR IS RESPONSIBLE FOR CLEANING ALL SEDIMENT OUT OF EXISTING RIGHT-OF-WAY.
3. CONTRACTOR IS RESPONSIBLE FOR MAINTAINING ALL STORM RUN OFF ON SITE.
4. REPAIR OF DAMAGED FACILITIES AND CLEAN-UP OF SEDIMENT SHALL BE THE RESPONSIBILITY OF THE CONTRACTOR.
5. ALL EXPOSED EARTH SURFACES MUST BE PROTECTED FROM WIND AND WATER EROSION PRIOR TO FINAL ACCEPTANCE OF ANY PROJECT.
6. CONTRACTOR IS RESPONSIBLE FOR OBTAINING NPDES PERMIT FOR THE SITE.

ASPHALTIC CONCRETE PAVING SECTION

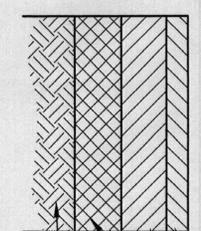




3" PLANT MIX BITUMINOUS PAVEMENT (ASPHALTIC CONCRETE) 2" LIFTS MAX.
6" AGGREGATE BASE COURSE
MIN. 12" OVEREXCAVATED & RECOMPACTED NATIVE SOIL TO A MINIMUM OF 95% OF MAXIMUM DENSITY AS DETERMINED BY ASTM D-1557
8" SCARIFIED & RECOMPACTED SOIL TO A MINIMUM OF 95% OF MAXIMUM DENSITY AS DETERMINED BY ASTM D-1557

PORTLAND CEMENT PAVING SECTION

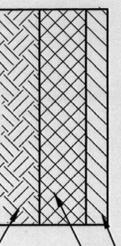

7" PCC
MIN. 12" OVEREXCAVATED & RECOMPACTED NATIVE SOIL TO A MINIMUM OF 95% OF MAXIMUM DENSITY AS DETERMINED BY ASTM D-1557
8" SCARIFIED & RECOMPACTED SOIL TO A MINIMUM OF 95% OF MAXIMUM DENSITY AS DETERMINED BY ASTM D-1557

HEAVY DUTY PAVEMENT

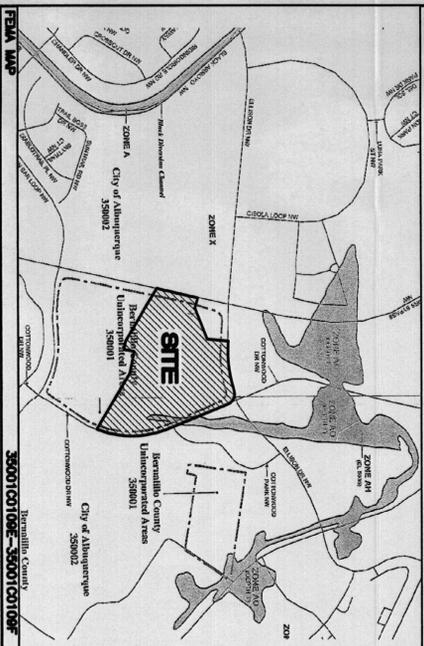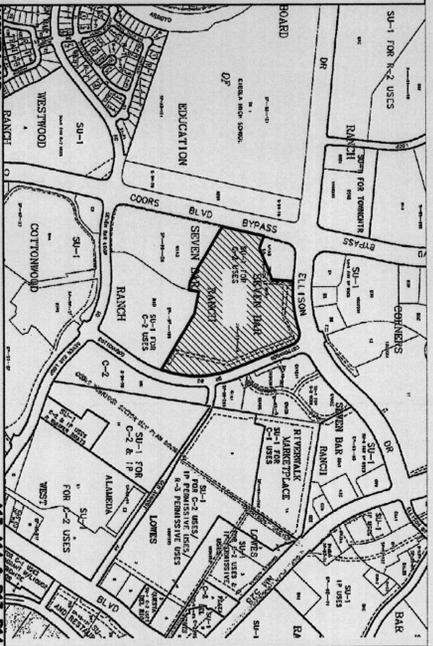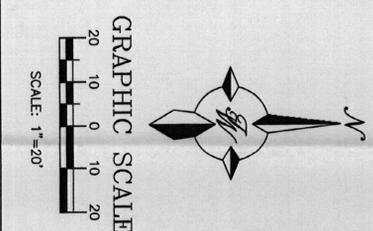

NOTES
1. ALL SPOT ELEVATIONS REPRESENT FLOWLINE ELEVATION UNLESS OTHERWISE NOTED.

ROUGH GRADING APPROVAL

CAUTION
ALL EXISTING UTILITIES SHOWN WERE OBTAINED FROM RESEARCH, AS-BUILTS, SURVEYS OR INFORMATION PROVIDED BY OTHERS. IT SHALL BE THE SOLE RESPONSIBILITY OF THE CONTRACTOR TO VERIFY THE LOCATION AND DEPTH OF ALL UTILITIES PRIOR TO ANY CONSTRUCTION. THE CONTRACTOR SHALL BE RESPONSIBLE FOR OBTAINING ALL NECESSARY PERMITS AND APPROVALS FROM THE CITY OF ALBUQUERQUE AND THE STATE OF NEW MEXICO. THE CONTRACTOR SHALL BE RESPONSIBLE FOR OBTAINING ALL NECESSARY PERMITS AND APPROVALS FROM THE CITY OF ALBUQUERQUE AND THE STATE OF NEW MEXICO. THE CONTRACTOR SHALL BE RESPONSIBLE FOR OBTAINING ALL NECESSARY PERMITS AND APPROVALS FROM THE CITY OF ALBUQUERQUE AND THE STATE OF NEW MEXICO.

02-09-05
PERMIT ISSUE


ENGINEER'S SEAL
TERRA WEST, LLC
8509 JEFFERSON NE 87113
ALBUQUERQUE, NEW MEXICO (305)958-3100
P.E. #7868

WAL-MART #1397
STOCKROOM ADDITION
GRADING AND DRAINAGE
PLAN ENLARGED

2465-08B-12-13-04
SHEET #
C107
JOB #
24095

LEGEND

- EXISTING S&S MANHOLE
- x- 8" S&S- EXISTING SANITARY SEWER LINE
- ⊗ EXISTING METER
- ⊗ EXISTING VALVE W/BOX
- ⊗ EXISTING FIRE HYDRANT
- ⊗ EXISTING WATER LINE
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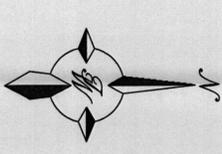


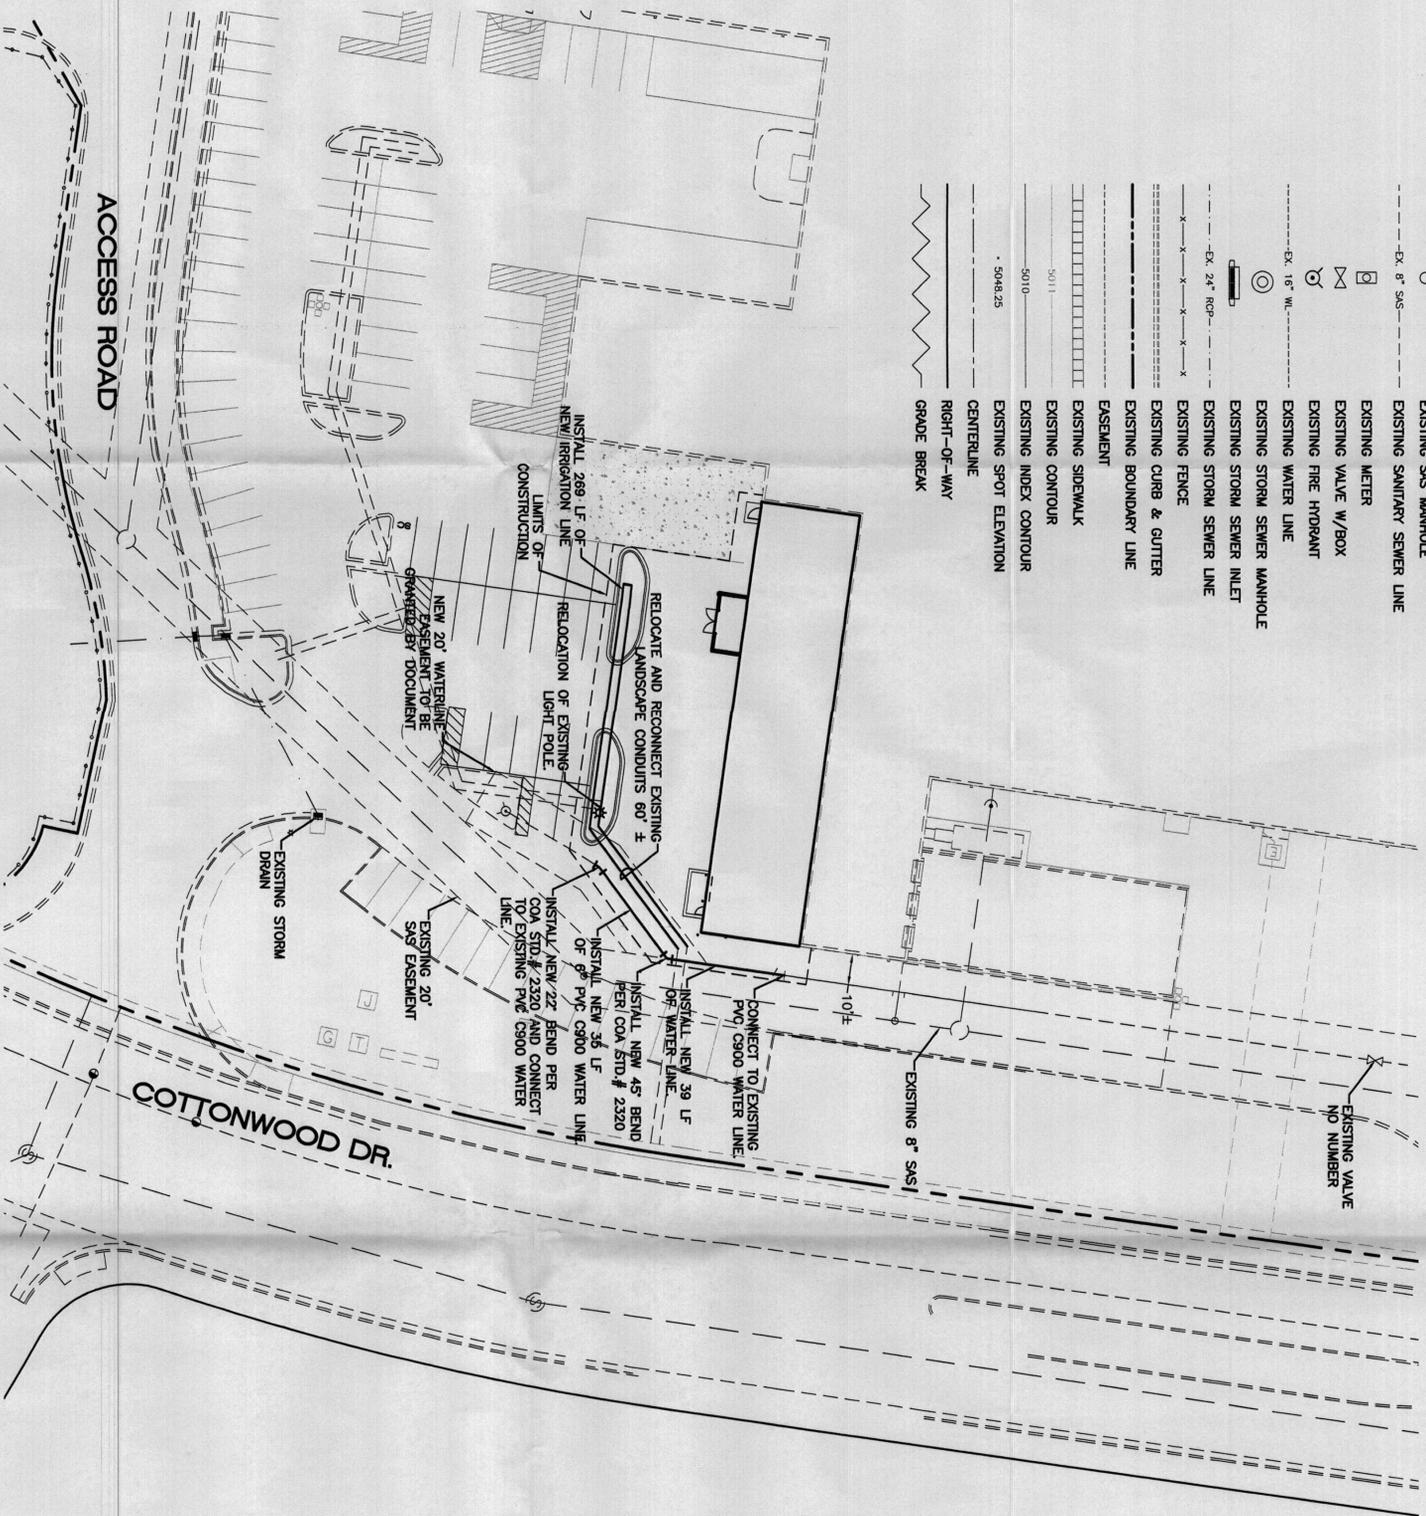NOTICE TO CONTRACTORS


1. AN EXCAVATION/CONSTRUCTION PERMIT WILL BE REQUIRED BEFORE BEGINNING ANY WORK WITHIN CITY RIGHT-OF-WAY. AN APPROVED COPY OF THESE PLANS MUST BE SUBMITTED AT THE TIME OF APPLICATION FOR THIS PERMIT.
2. ALL WORK DETAILED ON THESE PLANS TO BE PERFORMED, EXCEPT AS OTHERWISE STATED OR PROVIDED HEREON, SHALL BE CONSTRUCTED AND COMPLETED WITHIN THE SPECIFIC TIME PERIODS FOR WATER AND WASTEWATER FACILITIES (MOST RECENT REVISIONS).
3. TWO WORKING DAYS PRIOR TO ANY EXCAVATION, CONTRACTOR MUST CONTACT NEW MEXICO ONE CALL SYSTEM (286-1999), FOR LOCATION OF EXISTING UTILITIES. THREE WORKING DAYS PRIOR THE CONTRACTOR MUST CONTACT MMU (998-2861).
4. PRIOR TO CONSTRUCTION, THE CONTRACTOR SHALL EXAMINE AND VERIFY THE HORIZONTAL AND VERTICAL LOCATIONS OF ALL CONSTRUCTIONS. SHOULD A CONFLICT EXIST, THE CONTRACTOR SHALL NOTIFY THE ENGINEER SO THAT THE CONFLICT CAN BE RESOLVED WITH A MINIMUM AMOUNT OF DELAY.
5. BACKFILL COMPACTION SHALL BE ACCORDING TO RESIDENTIAL STREET USE.
6. MAINTENANCE OF THESE FACILITIES SHALL BE THE RESPONSIBILITY OF THE OWNER OF THE PROPERTY SERVED.
7. WORK ON ARTERIAL STREETS SHALL BE PERFORMED ON A 24-HOUR BASIS.
8. CONTRACTOR IS RESPONSIBLE TO PROVIDE UTILITY STUBS 5' FROM BUILDING
9. CONTRACTOR SHALL DETERMINE LOCATION OF ANY UNDERGROUND FACILITY IN OR NEAR WORK AREAS, INCLUDING REQUESTS TO OWNERS/OPERATORS OF SAID FACILITIES PER SECTION 62-14-5 NMSA 1978.
10. CONTRACTOR SHALL PLAN ALL EXCAVATION TO MINIMIZE INTERFERENCE OR DAMAGE OF UNDERGROUND FACILITIES.
11. CONTRACTOR SHALL PROVIDE ADVANCE TELEPHONE NOTICE OF COMMENCEMENT, EXTENT AND DURATION OF ALL EXCAVATION WORK TO THE ONE-CALL NOTIFICATION SYSTEM, DURING THE ONE-CALL NOTIFICATION PERIOD. CONTRACTORS NEAR THE EXCAVATION SHALL NOTIFY THE FACILITY OWNERS/OPERATORS NEAR THE EXCAVATION CENTER. IN ORDER THAT OWNERS/OPERATORS MAY LOCATE AND MARK UNDERGROUND FACILITY PER SECTION 62-14-5 NMSA 1978 PRIOR TO ANY COMMENCEMENT OF WORK. CONTRACTOR SHALL REQUEST REAFFIRMATION OF LOCATION EVERY TEN (10) WORKING DAYS AFTER INITIAL REQUEST.
12. CONTRACTOR SHALL MAINTAIN EIGHTEEN (18) INCHES BETWEEN EXISTING UNDERGROUND FACILITIES FOR WHICH HAVE BEEN PREVIOUSLY IDENTIFIED AND MARKED BY THE OWNERS/OPERATORS OF SAID FACILITIES. CUTTING EDGE OR POINT OF ANY MECHANICAL EXCAVATING EQUIPMENT UTILIZED IN EXCAVATION AREA WILL BE USED IN A MANNER NECESSARY TO PREVENT DAMAGE TO EXISTING UNDERGROUND FACILITIES.
13. CONTRACTOR SHALL PROVIDE SUPPORT FOR EXISTING UNDERGROUND FACILITIES IN OR NEAR EXCAVATION AREA AS NECESSARY TO PREVENT DAMAGE TO SAID FACILITIES.
14. CONTRACTOR SHALL BACKFILL ALL EXCAVATIONS IN A MANNER AND WITH MATERIALS AS MAY BE NECESSARY TO PREVENT DAMAGE TO AND PROVIDE RELIABLE SUPPORT DURING AND FOLLOWING BACK FILLING ACTIVITIES FOR PREEXISTING UNDERGROUND FACILITIES IN OR NEAR EXCAVATION AREA.
15. CONTRACTOR SHALL IMMEDIATELY NOTIFY BY TELEPHONE THE OWNER/OPERATOR OF ANY UNDERGROUND FACILITY WHICH MAY HAVE BEEN DAMAGED OR DISLODGED DURING EXCAVATION WORK.
16. CONTRACTOR SHALL NOT MOVE OR OBLITERATE MARKINGS MADE PURSUANT TO CHAPTER 62, ARTICLE 14 NMSA 1978, OR FABRICATE MARKINGS IN A UNMARKED LOCATION FOR THE PURPOSE OF CONCEALING OR AVOIDING LIABILITY FOR VIOLATION OF OR NONCOMPLIANCE WITH THE PROVISIONS OF CHAPTER 62, ARTICLE 11 NMSA 1978.

GENERAL NOTES:

1. ALL WATER AND SEWER UTILITY WORK TO BE DONE IN ACCORDANCE WITH N.M.U.I. STANDARDS AND SPECIFICATIONS LATEST EDITION.
2. 4" MINIMUM BURY REQUIRED FOR ALL UTILITIES UNLESS OTHERWISE NOTED.
3. REFERENCE ARCHITECTURAL PLANS FOR WATER LINE RISER LOCATIONS.
4. CLEAN CUTS ARE TO BE BUILT PER UNIFORM PLUMBING CODE STANDARDS.
5. ALL PLUMBING PIPE MATERIAL TO BE USED PER UPC.
6. FIRE LINE AND DOMESTIC WATERLINE MUST HAVE BACKFLOW PREVENTORS PER UPC. IF BACKFLOW PREVENTOR IS INSTALLED EXTERIOR OF BUILDING A HOT BOX SHALL BE INSTALLED AND USED.
7. ALL EXCAVATION, TRENCHING AND SHORING ACTIVITIES MUST BE CARRIED OUT IN ACCORDANCE WITH OSHA 29 CFR 1926.850 SUBPART F.
8. ALL UTILITY DISTANCES SHOWN ARE FOR REFERENCE ONLY.



GRAPHIC SCALE
SCALE: 1"=30'

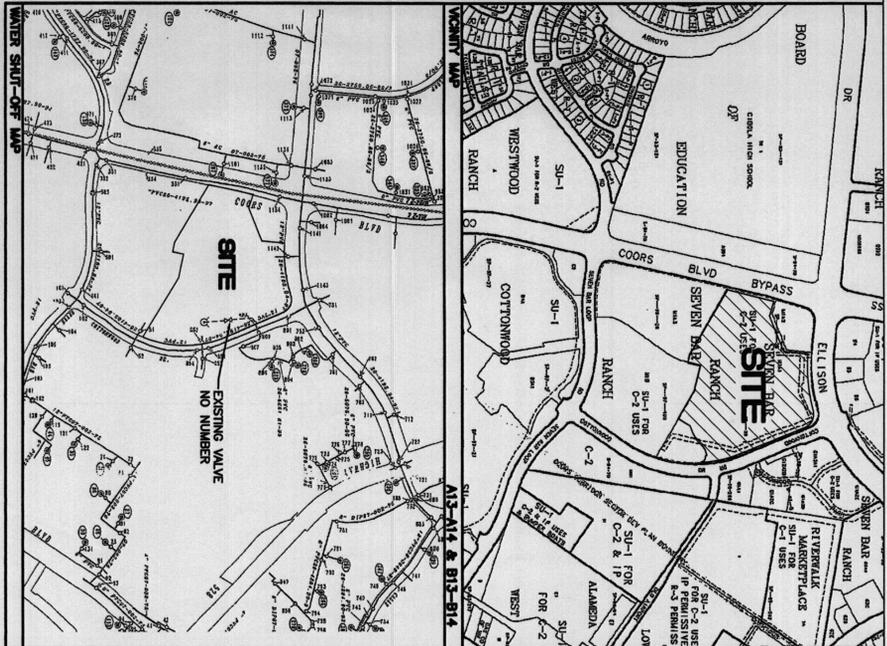

- NOTES:**
1. WATER SHUTOFF SHALL BE COORDINATED WITH NEW MEXICO UTILITIES, INC.
 2. ONLY WATER SYSTEMS PERSONNEL ARE AUTHORIZED TO OPERATE VALVES.
 3. NOTIFY NEW MEXICO UTILITIES (998-2861) THREE(3) WORKING DAYS IN ADVANCE OF EXECUTION OF THE WATER SHUTOFF PLAN
 4. ALL WATERLINE CONNECTIONS, CAP, JOINTS TO BE BLOCKED PER DETAILS THIS SHEET
 5. ALL WATERLINES TO BE PVC, UNLESS OTHERWISE NOTED.
 6. SHUTOFF VALVES INDICATED IN THE ABOVE PLAN IN THE EVENT OF EMERGENCY


RESTRAINED JOINT LENGTHS FOR HORIZONTAL BENDS, VALVES, AND DEAD ENDS (EACH SIDE)			
SIZE	90°	HORIZONTAL BENDS	AND DEAD ENDS (EACH SIDE)
12	15	3	1
10	13	3	1
8	11	4	2
6	8	3	2
4	6	2	1
			N/A
			13

MMU APPROVAL

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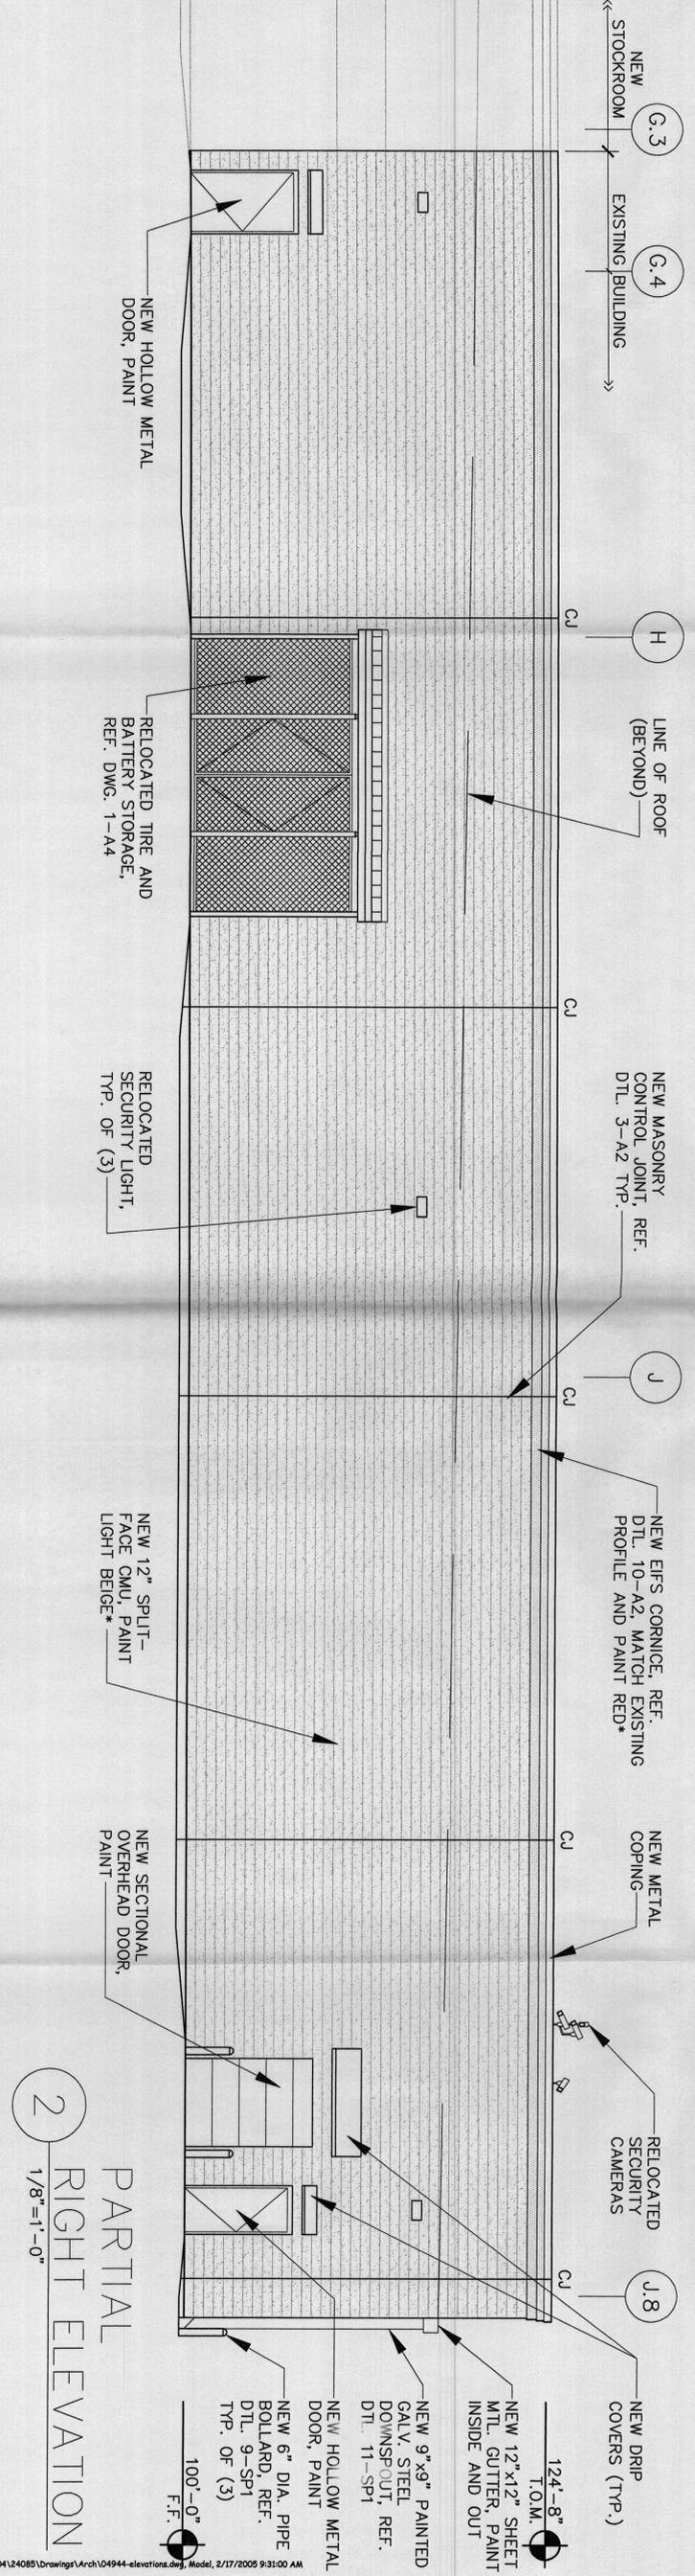
**02-09-05
PERMIT ISSUE**

ENGINEER'S SEAL	DRAWN BY DATE
	DWAN 03-01-05
WAL-MART #1997 STOCKROOM ADDITION	DATE
MASTER UTILITY PLAN	2/05-WB-12-13-04.dwg
TERRIA WEST, LLC 8509 JEFFERSON, NEW MEXICO 87113 (505) 858-3100	SHEET # C108
ROWALD R. BOHANNAN P.E. #7688	JOB # 24065

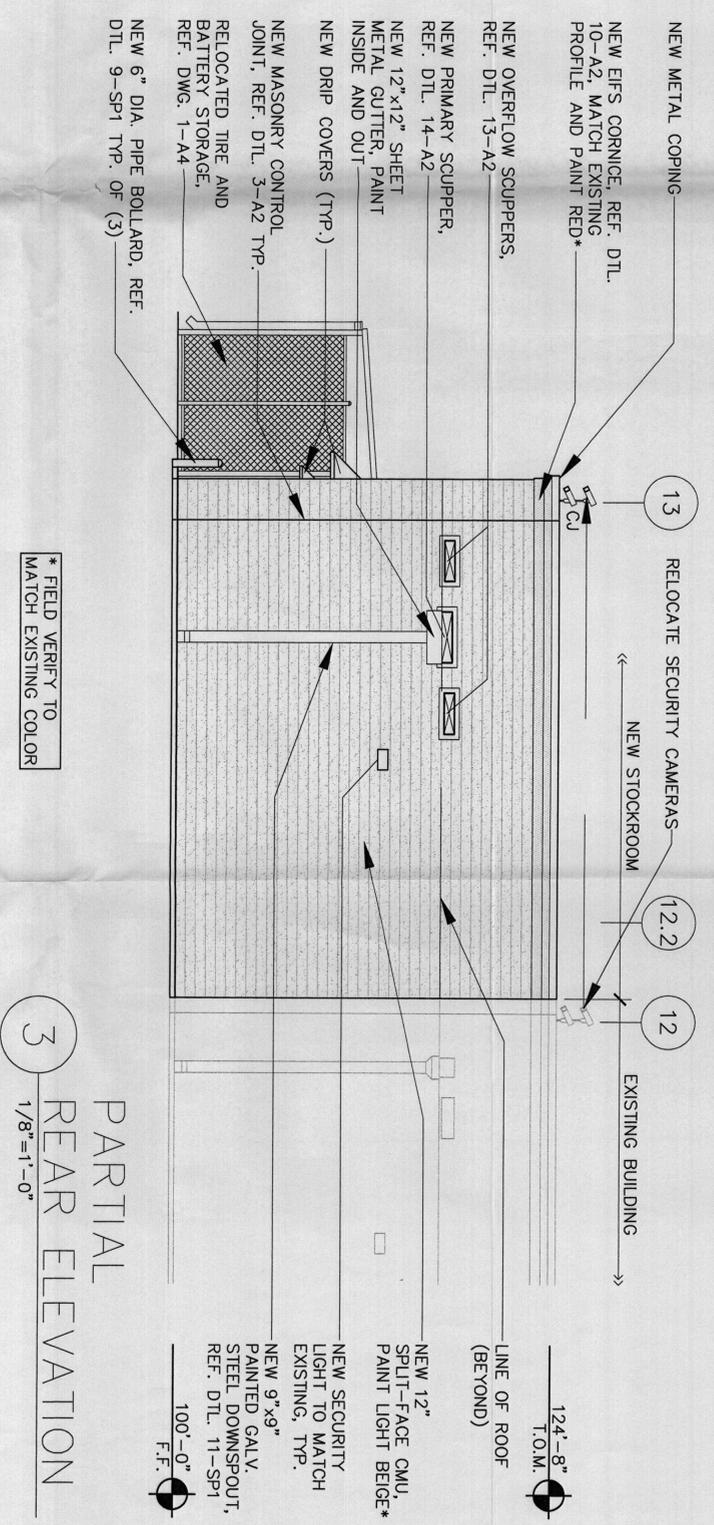





PARTIAL
REAR ELEVATION
1/8"=1'-0"

* FIELD VERIFY TO
MATCH EXISTING COLOR



PARTIAL
RIGHT ELEVATION
1/8"=1'-0"

EXISTING WAL-MART
 SUPER CENTER #1397
 GROSS S.F. = 210,187
 FINISHED FLOOR ELEV: 5050.78

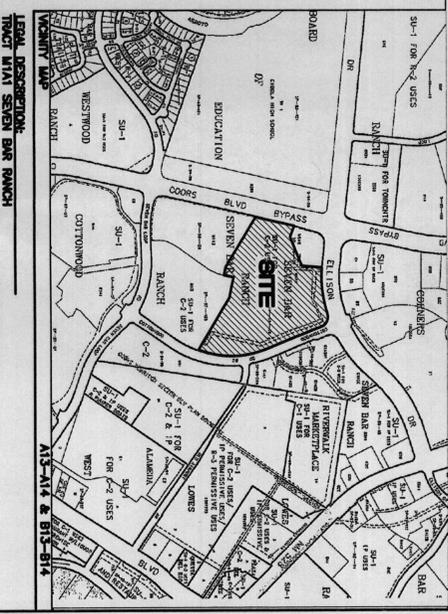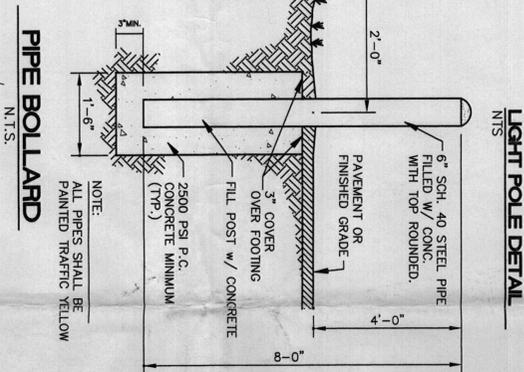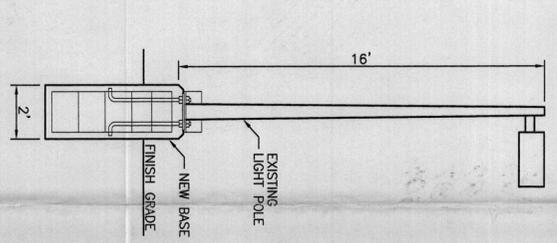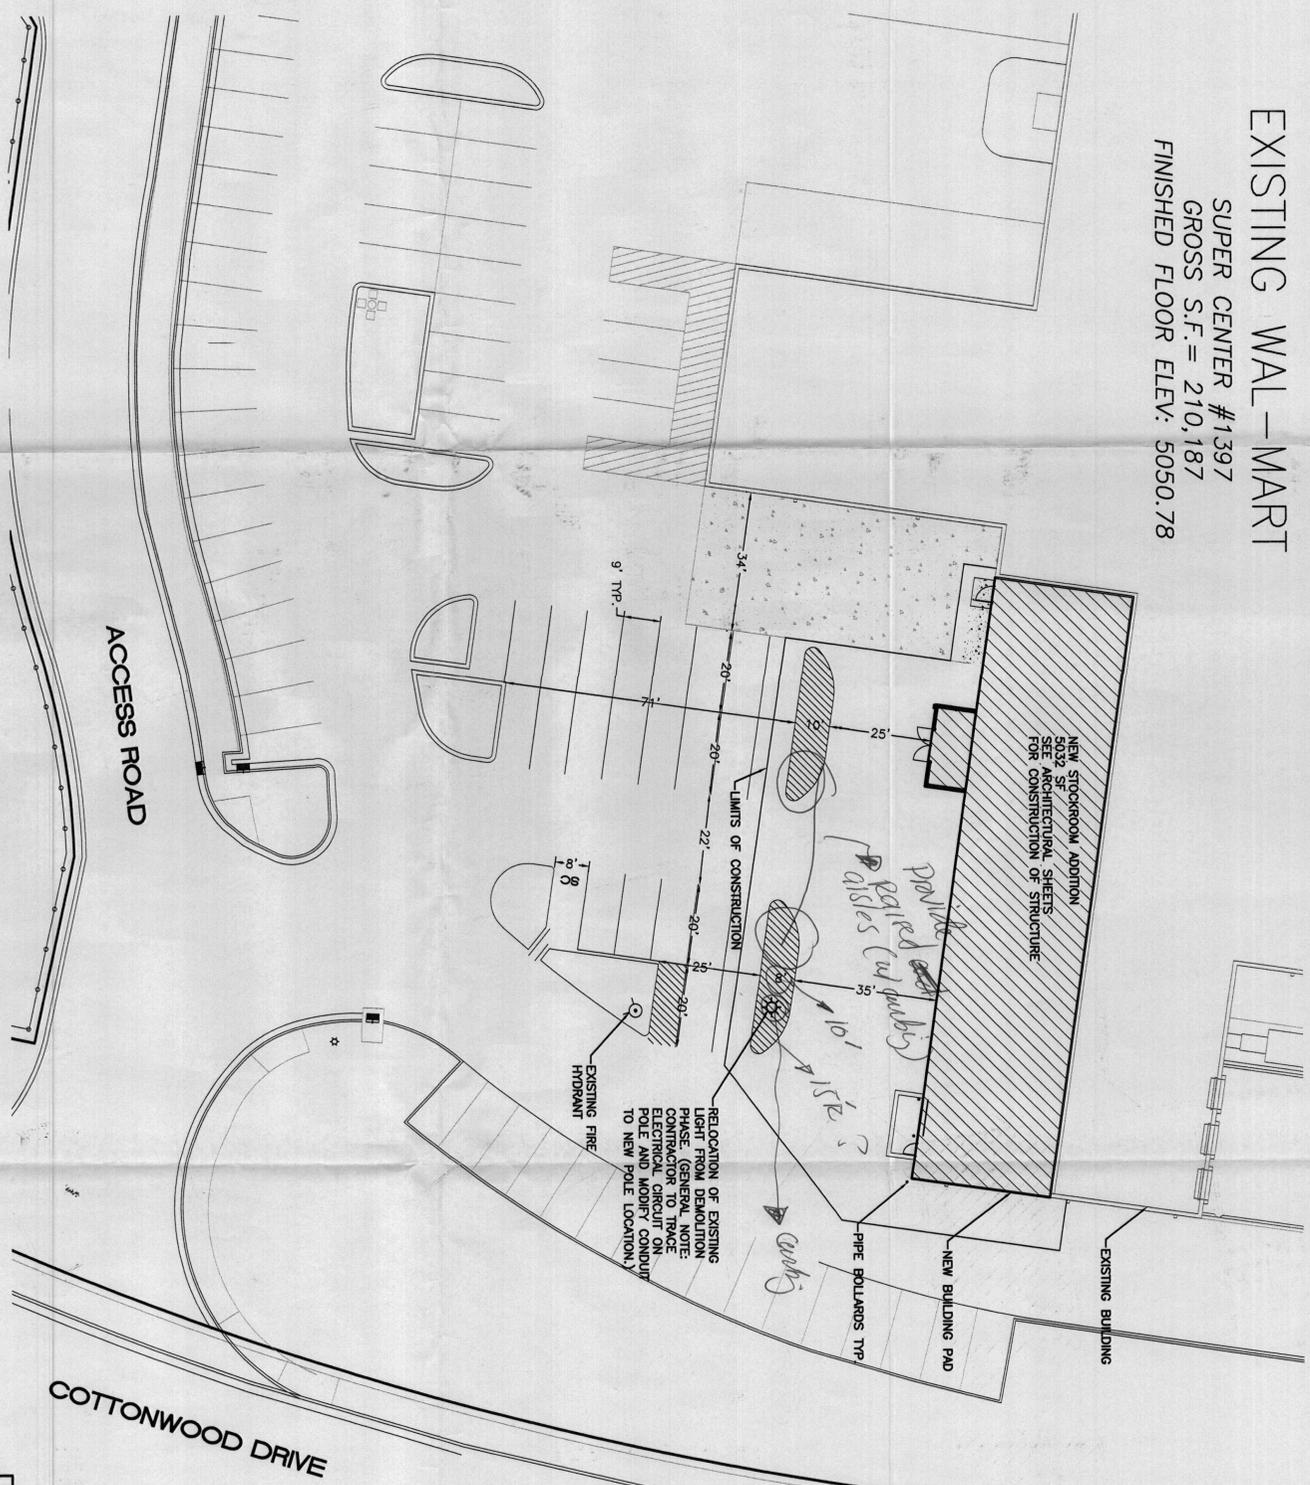

SITE DATA

PROPOSED USAGE: GENERAL RETAIL USE

LOT AREA: 783,749 SF (17.9923 ACRES)

BUILDING AREA: 210,187 SF

STOCKROOM EXPANSION AREA: 5,032 SF

PARKING PROVIDED: 938 SPACES

PARKING REQUIRED: 756 SPACES (INCLUDING EMPLOYEE)

HC PARKING PROVIDED: 25 SPACES (INCLUDING 3 VAN ACCESSIBLE)

HC PARKING REQUIRED: 21 SPACES

LEGEND

○ EXISTING S&S MANHOLE

--- EX. 8" S&S EXISTING SANITARY SEWER LINE

--- EXISTING VALVE W/ BOX

--- EXISTING FIRE HYDRANT

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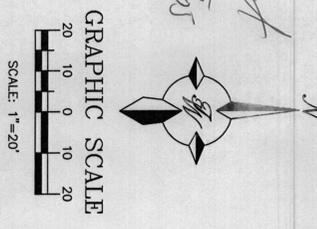
--- EXISTING CONTOUR

--- 5046.25 EXISTING SPOT ELEVATION

--- CENTERLINE

--- RIGHT-OF-WAY

--- GRADE BREAK



PROJECT NUMBER: _____

APPLICATION NUMBER: _____

This plan is consistent with the specific Site Development Plan approved by the Engineering Department of the City of Albuquerque, New Mexico, and the findings and conditions in the Official Modification of Decision are satisfied.

Is an Infrastructure Link required? () Yes () No If Yes, then a set of approved DDC plans with a work order is required for any construction within Public Right-of-Way or for construction of public improvements.

DRB SITE DEVELOPMENT PLAN SIGNOFF APPROVAL:

Traffic Engineer, Transportation Division _____ Date _____

Utilities Development _____ Date _____

Parks & Recreation Department _____ Date _____

City Engineer _____ Date _____

* Environmental Health Department (conditional) _____ Date _____

Solid Waste Management _____ Date _____

DRB Chairperson, Planning Department _____ Date _____

* Environmental Health, if necessary _____ Date _____

ENGINEER'S SEAL

SCALE

WAL-MART #1397 STOCKROOM ADDITION

SITE PLAN FOR BUILDING PERMIT

2/15/05
 2/15/05
 nst

TIENNA WEST LLC
 8509 JEFFERSON NE
 ALBUQUERQUE, NEW MEXICO 87113
 (505) 858-5100

02-09-05 PERMIT ISSUE

DRAWN BY EMT DATE 01-07-05

2465-0198-12-13-04

SHEET # C106

JOB # 24095