## DESIGN GUIDELINES

#### PARKING/CIRCULATION

- 1. The maximum allowed parking shall be equal to the required parking plus 10%.
- 2. ADA compliant parking shall be located adjacent to the building entry.
- 3. For office buildings, pedestrian crossings shall be a minimum width of 6-feet. They shall be clearly demarcated with textured paving and shall be provided where pedestrian paths cross vehicular entrances and drive aisles.
- 4. Shaded pedestrian access shall be provided, including a clear 6-foot-wide path with adjacent trees spaced approximately 25-feet on center within planters that have a minimum interior dimension of 5-feet square (or equivalent).
- 5. For office buildings, a shaded sidewalk that is a minimum of 15-feet-wide shall be provided along the entrance side of the building. Shade can be provided with architecturally integrated portals or canopies, or by trees placed at intervals of approximately 25 feet on center in planters with a minimum interior dimension of 5-feet square (or equivalent).
- 6. For buildings, an outdoor patio space that is a minimum of 500 square feet in size with tables and seating shall be provided. The patio shall have adequate shading provided by trees and/or shade structure that integrates with building architecture. 7. Convenient pedestrian connections shall be provided from each building to the
- internal circulation system and to adjacent roadways.
- 8. Bicycle racks shall be conveniently located near building entrances but not within pedestrian pathways or landscape areas.
- 9. There shall be a 6-foot clear pedestrian ways to connect Tract G-3-A to H-1-A; and Tract G-3-B to Tract H-1-A.

#### LANDSCAPING & SCREENING

- 10. A mix of evergreen (coniferous) and deciduous trees shall be used within parking areas. Buffer areas shall include a mix of evergreen and deciduous trees.
- 11. Landscaping regulations require that 75% of landscape areas over 36 square feet in size must be covered with living, vegetative material. High-water use turf must be limited in application to 20% of the landscape area.
- 12. Parapets and/or architectural tents shall be used to screen mechanical equipment and penetrations from the commercial development to the adjacent property.
- 13. Perimeter walls shall comply with the Planning Department's Guidelines for perimeter
- 14. No chain-link, razor wire or plastic vinyl fencing is permitted.

## ARCHITECTURE


- 15. The top of all rooftop equipment shall be below the top of parapet and screened from view from nearby properties. Screen walls shall screen all ground-mounted equipment with the top of equipment below the top of screen wall.
- 16. No plastic or vinyl building panels, awnings, or canopies are permitted. Awnings and canopies shall be integrated with building architecture.
- 17. No freestanding cell towers or antenna shall be permitted; antenna shall be integrated into the building architecture.
- 18. ATM's should be architecturally integrated with building design.
- 19. Loading docks shall be screened by walls and covers that are architecturally integrated with the building.
- 20. No generic franchise architecture shall be allowed.
- 21. All out buildings and canopies shall be architecturally intergrated and compatible in materials and design.
- 22. Refuse enclosures shall be compatible in design, color, and material with building architecture. If gates are provided, they shall be opaque; chainlink gates are not allowed.

## SIGNAGE

- 23. Monument signs which are integrated with building colors and materials are the only free standing signs allowed.
- 24. Building-mounted signs shall consist of individual channel letters. No illuminated plastic panel signs are allowed except logos.
- 25. Monument signage shall be limited to a maximum of 10-feet in height, 100 square feet per face. Building-mounted signage shall be a maximum of 6% to the facade to which is applied and a maximum of 3 building facades. Maximum letter size shall be three feet, maximum logo size shall be 3' x 3'.

## LIGHTING

- 26. The location of the light poles shall be included on the Site Plans for Building Permit. Light fixtures shall be a maximum of 20 feet high. The light fixtures shall be fully-shielded fixtures lamps so that no fugitive light shall escape beyond the property line. All light fixtures shall be full-cutoff to prevent fugitive light; no light source shall be visible from
- 27. Lighting within 100 feet of residential development shall be limited to 16 feet in height.

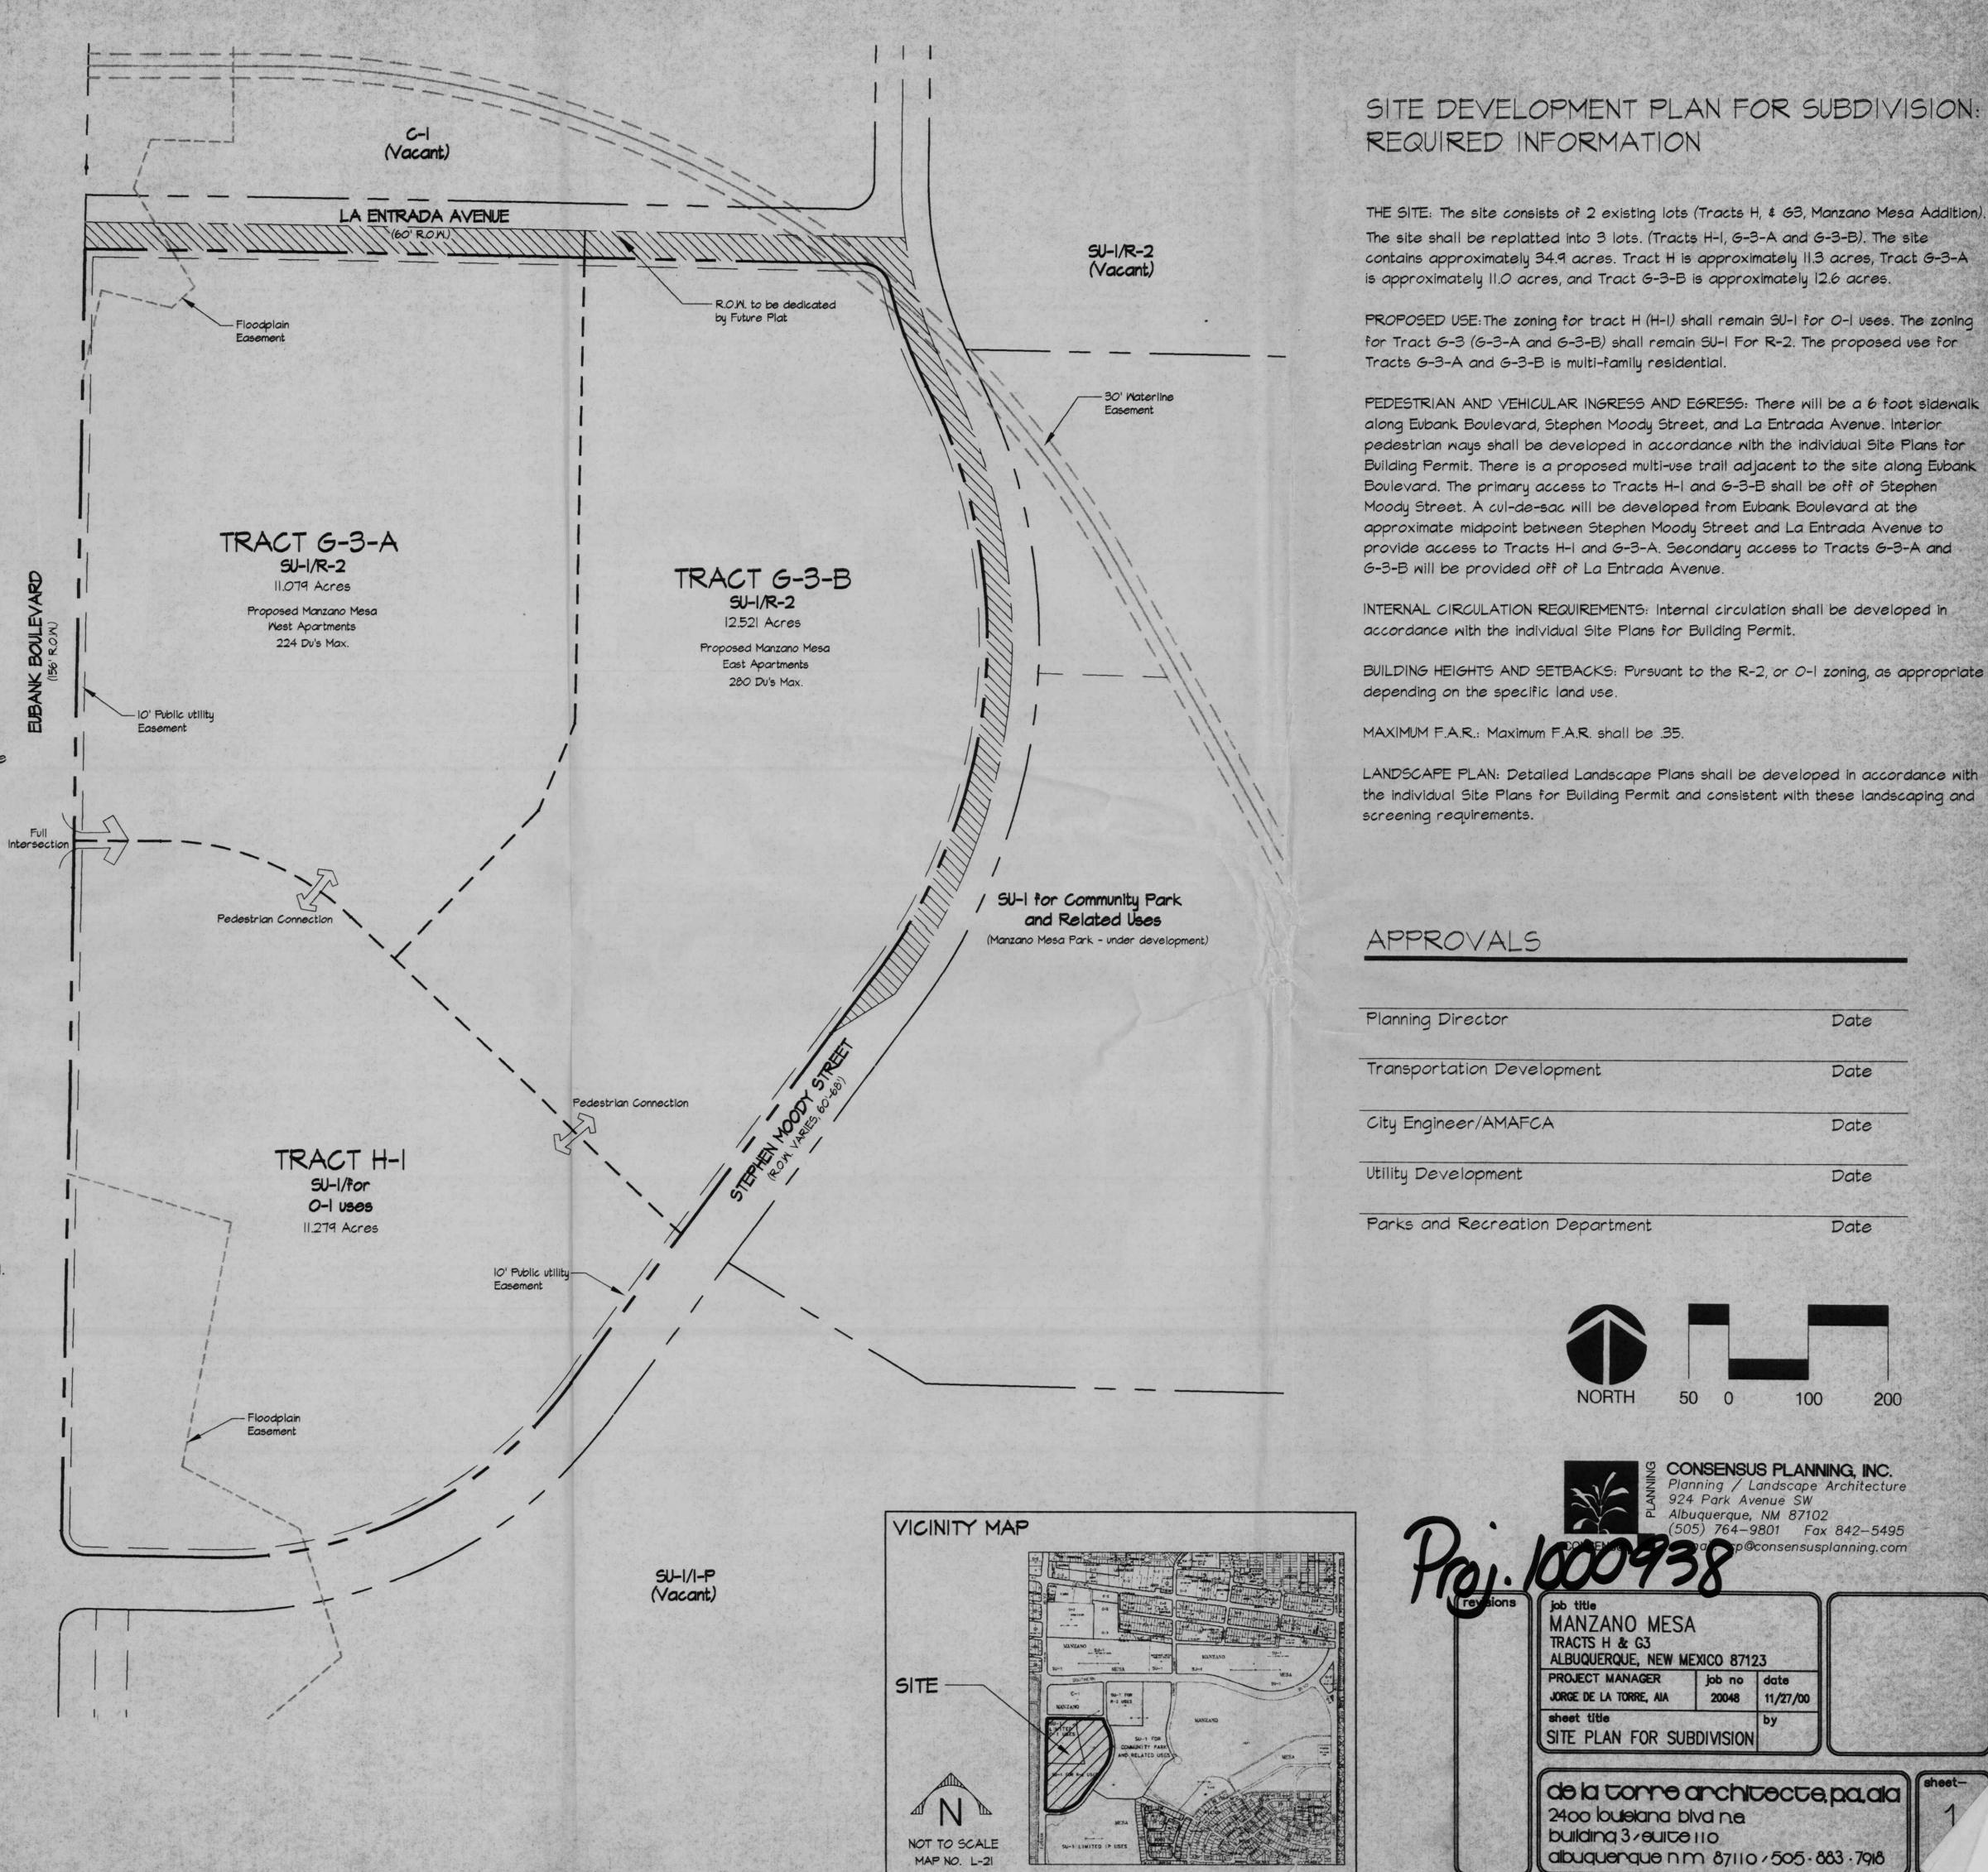

Date


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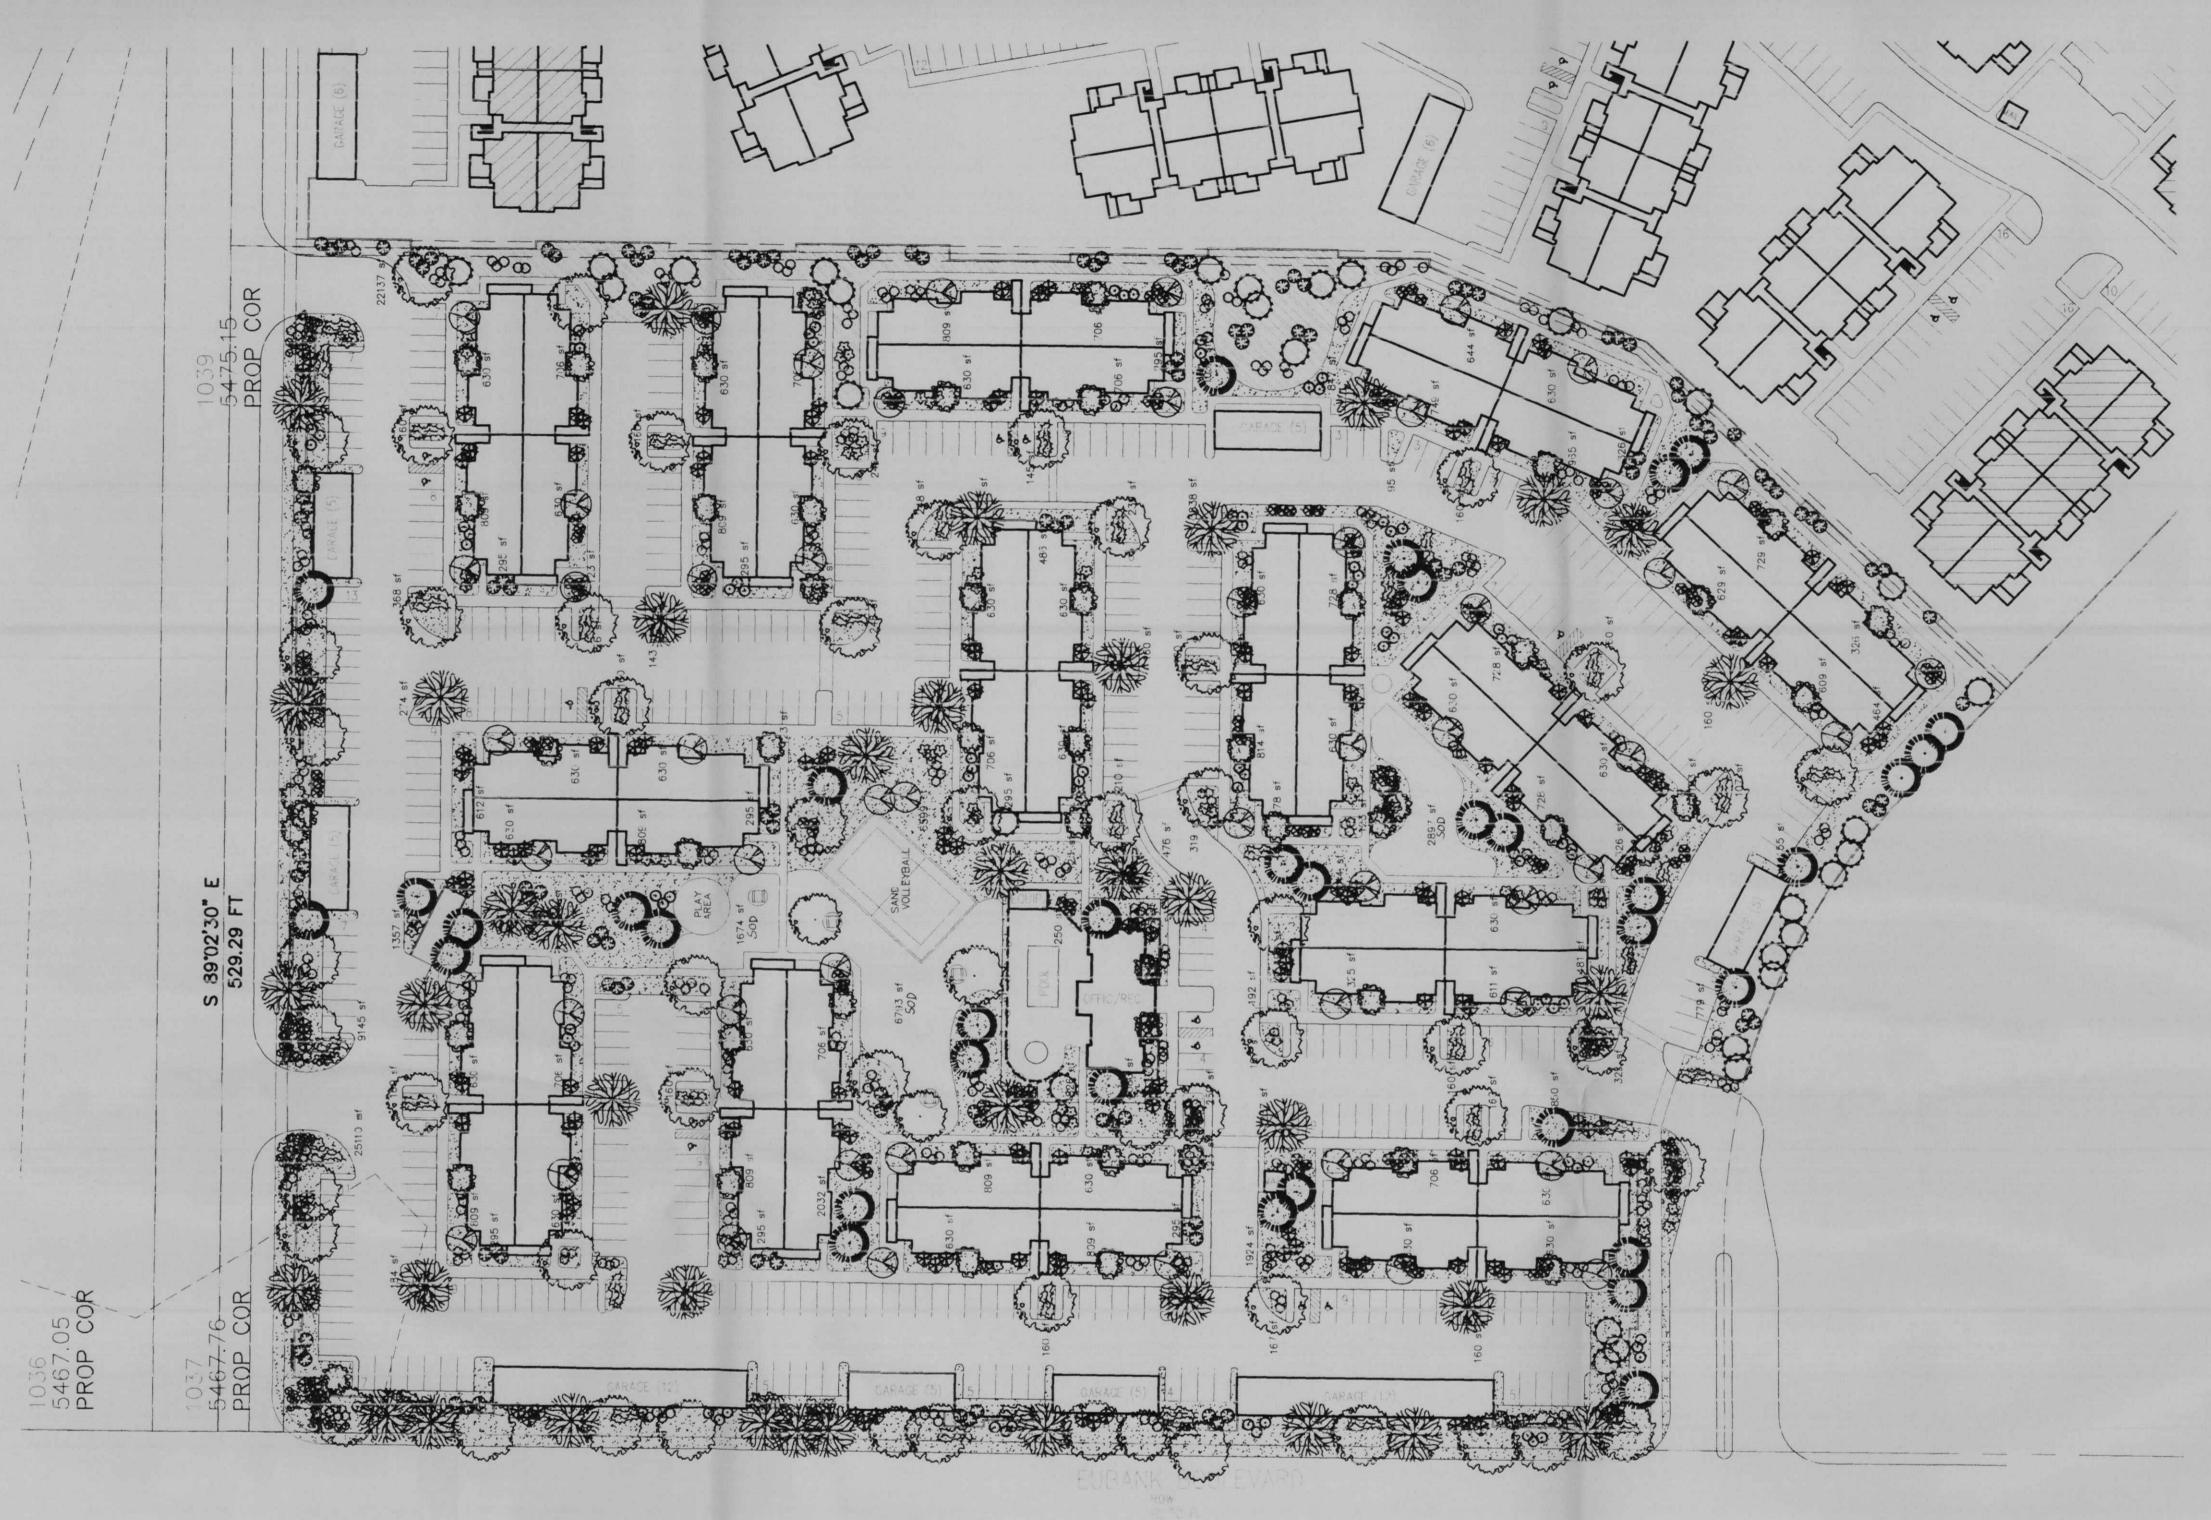
Date

Date

Date

11/27/00



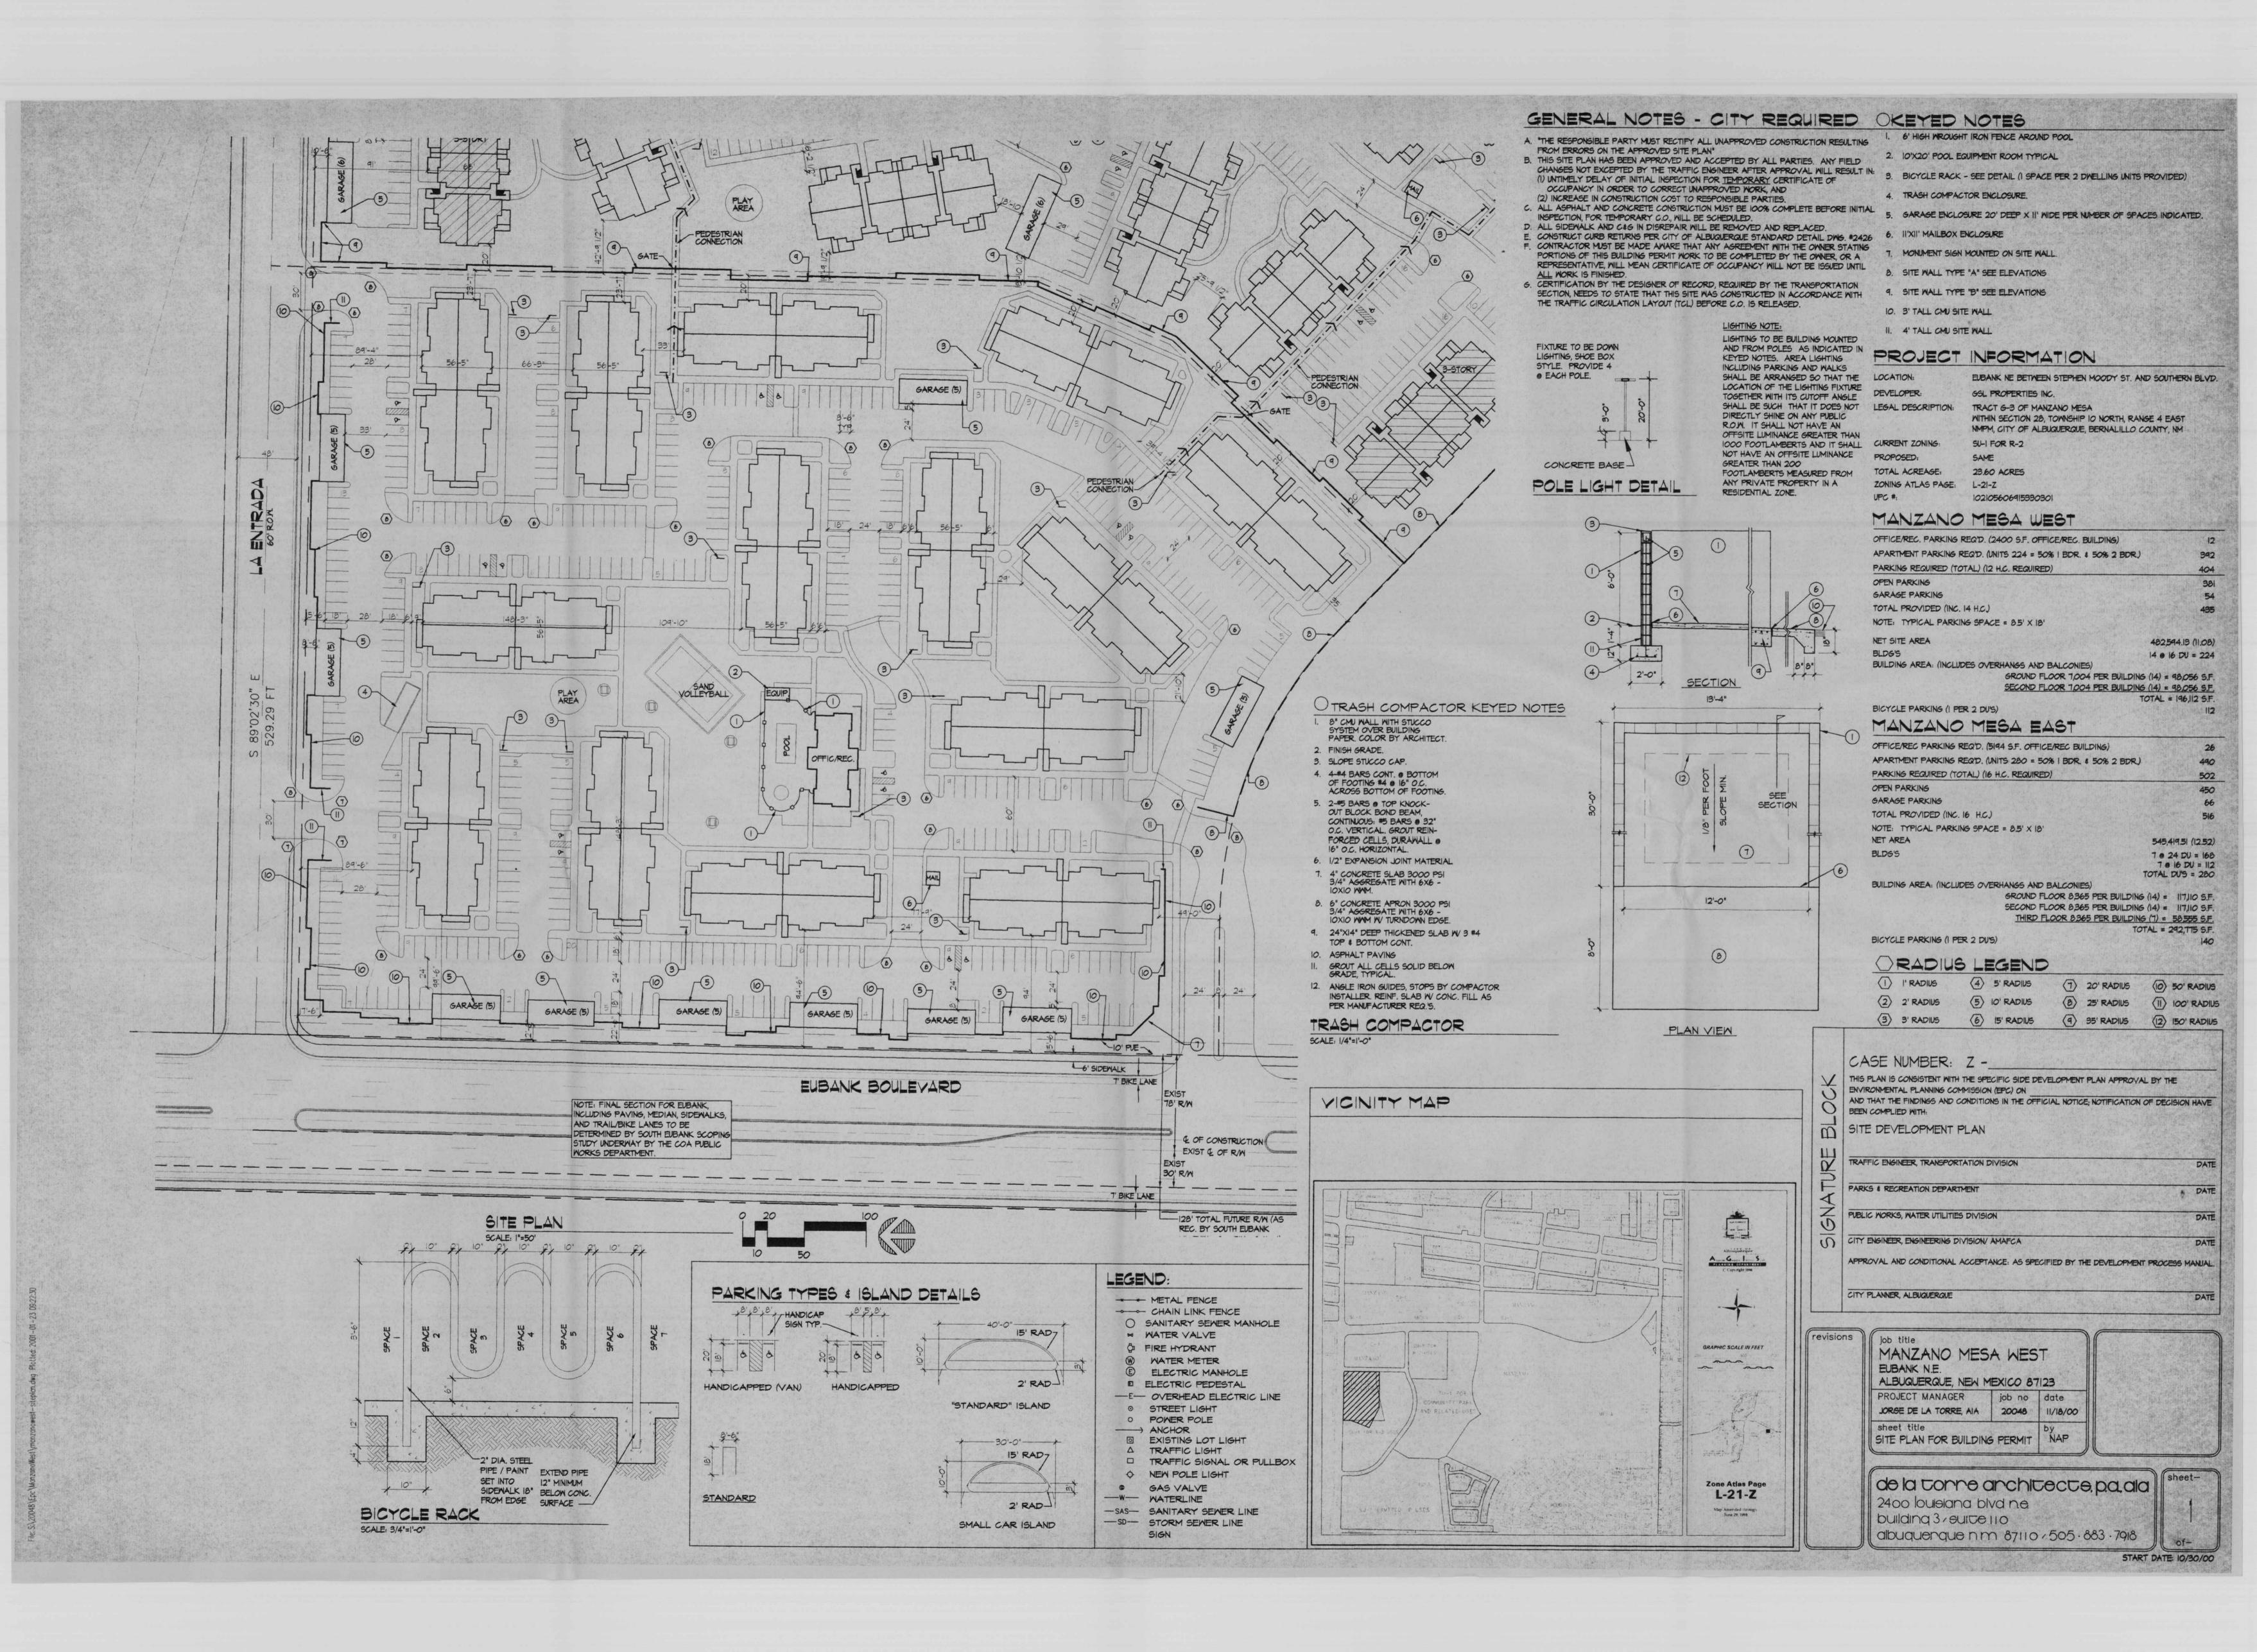

LANDSCAPE NOTES:

Landscape maintenance shall be the responsibility of the Property Owner.

It is the intent of this plan to comply with the City Of Albuquerque, Water Conservation Landscaping and Water Waste Ordinance, planting restriction approach.

or imply exemption from water waste provisions of the Water Conservation Landscaping and Water Waste Ordinance. Water management is the sole responsibility of the Property Owner.

City of Albuquerque Zoning Code, Street Tree Ordinance, Pollen Ordinance, and Water Conservation Landscaping, and Water Waste Ordinance. In general, water conservative, environmentally sound landscape principles will be followed in design and installation.

3/4" Santa Ana Tan Gravel over Filter Fabric shall be placed in all landscape areas which are

Irrigation shall be a complete underground system with Trees to receive (5) 1.0 GPH Drip Emitters and Shrubs to receive (2) 1.0 GPH Drip Emitters. Drip and Bubbler systems to be tied to 1/2" polypipe with flush caps at each end.

Run time per each drip valve will be approximately 15 minutes per day, to be adjusted according to the season.

Point of connection for irrigation system is unknown at current time and will be coordinated in the field.

Irrigation will be operated by automatic controller. Location of controller to be field determined and power source for controller to be provided by others.

Irrigation maintenance shall be the responsibility of the Property Owner.

## LANDSCAPE CALCULATIONS

NET LANDSCAPE AREA

TOTAL LOT AREA	479160	square	feet
TOTAL BUILDINGS AREA	100,237	square	feet
OFFSITE AREA	0	square	feet
NET LOT AREA	378923	square	feet
LANDSCAPE REQUIREMENT	15%		
TOTAL LANDSCAPE REQUIREMENT	56838	square	feet
TOTAL LANDSCAPE PROVIDED	157653	square	feet
TOTAL BED PROVIDED	124152	square	feet
TOTAL SOD PROVIDED	11364 (20%)	square	feet
TOTAL NATIVE SEED PROVIDED	22137	square	feet

#### STREET TREE REQUIREMENTS

Street trees required under the City Of Albuquerque Street Tree Ordinance are as follows:

Name of Street Required # 23 Provided # 23

Total number of trees on site as required by

The City Of Albuquerque are as follows:

Number of 1st story apartment units: 112 Number of 2nd story apartment units: 112

Number of trees to reach 25' at maturity required: 168 Number of trees to reach 25' at maturity provided: 335


# PLANT LEGEND




SHADE TREE 59
RAYWOOD ASH (H)
Fraxinus oxycarpa raywood
ARIZONA ASH (H)
Fraxinus velutina 2" Cal



SHADE TREE 40
THORNLESS HONEYLOCUST
Gleditsia triacanthos 'inermis'

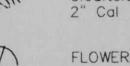

FLOWERING PEAR (H) 53 Pyrus calleryana 1 1/2" Cal

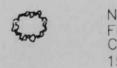

NEW MEXICO OLIVE/WASHINGTON HAWTHORN(M)54
Forestiera neomexicana
Crateagus phaenopyrum 15 Gal.



DESERT WILLOW (L) 31 Chilopsis linearis 15 Gal.




AUSTRIAN PINE (H) 36 Pinus nigra

INDIAN HAWTHORN (M) 110



SILVERBERRY (M) 173

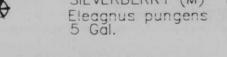

Raphiolepis indica 5 Cal. RUSSIAN SAGE (M) 93

Perovskia atriplicifolia 5 Gal. APACHE PLUME (L) 186 Eallugia paradoxa

AUTUMN SAGE (M) 141

PROSTRATE ROSEMARY (M) 110 Romarinus officianalis 5 gal

CHAMISA (L) 133 Chrysothamnus nauseosus


WILDFLOWER 52 1 Gal.

TAM JUNIPER (M) 150 Juniperus sabina 5 Cal.


BOSTON IVY 51 Parthenocissus tricuspidata



3/4" SANTA ANA TAN GRAVEL

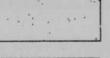

WITH FILTER FABRIC

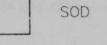

CRIMP STRAW NATIVE SEED



POP-UP SPRINKLER HEADS

COMMERCIAL GRADE

STEEL EDGING

LANDSCAPE ARCHITECTS & CONTRACTORS Cont. Lic. #26458 7909 Edith N.E. Albuquerque, NM 87184 Ph. (505) 898-9690 Fax (505) 898-7737 it@hilltoplandscaping.com


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UQUERQUE, NEW MEXICO 871

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In building Syeutte in a

START DATE 10/30/00 File: //Pooh/AutoCAD/ACAD DWC/COMMERCIAL/CSL Eubank & Southern/manzano-phasel.dwg Plotted: 2000-11-22 1552.21




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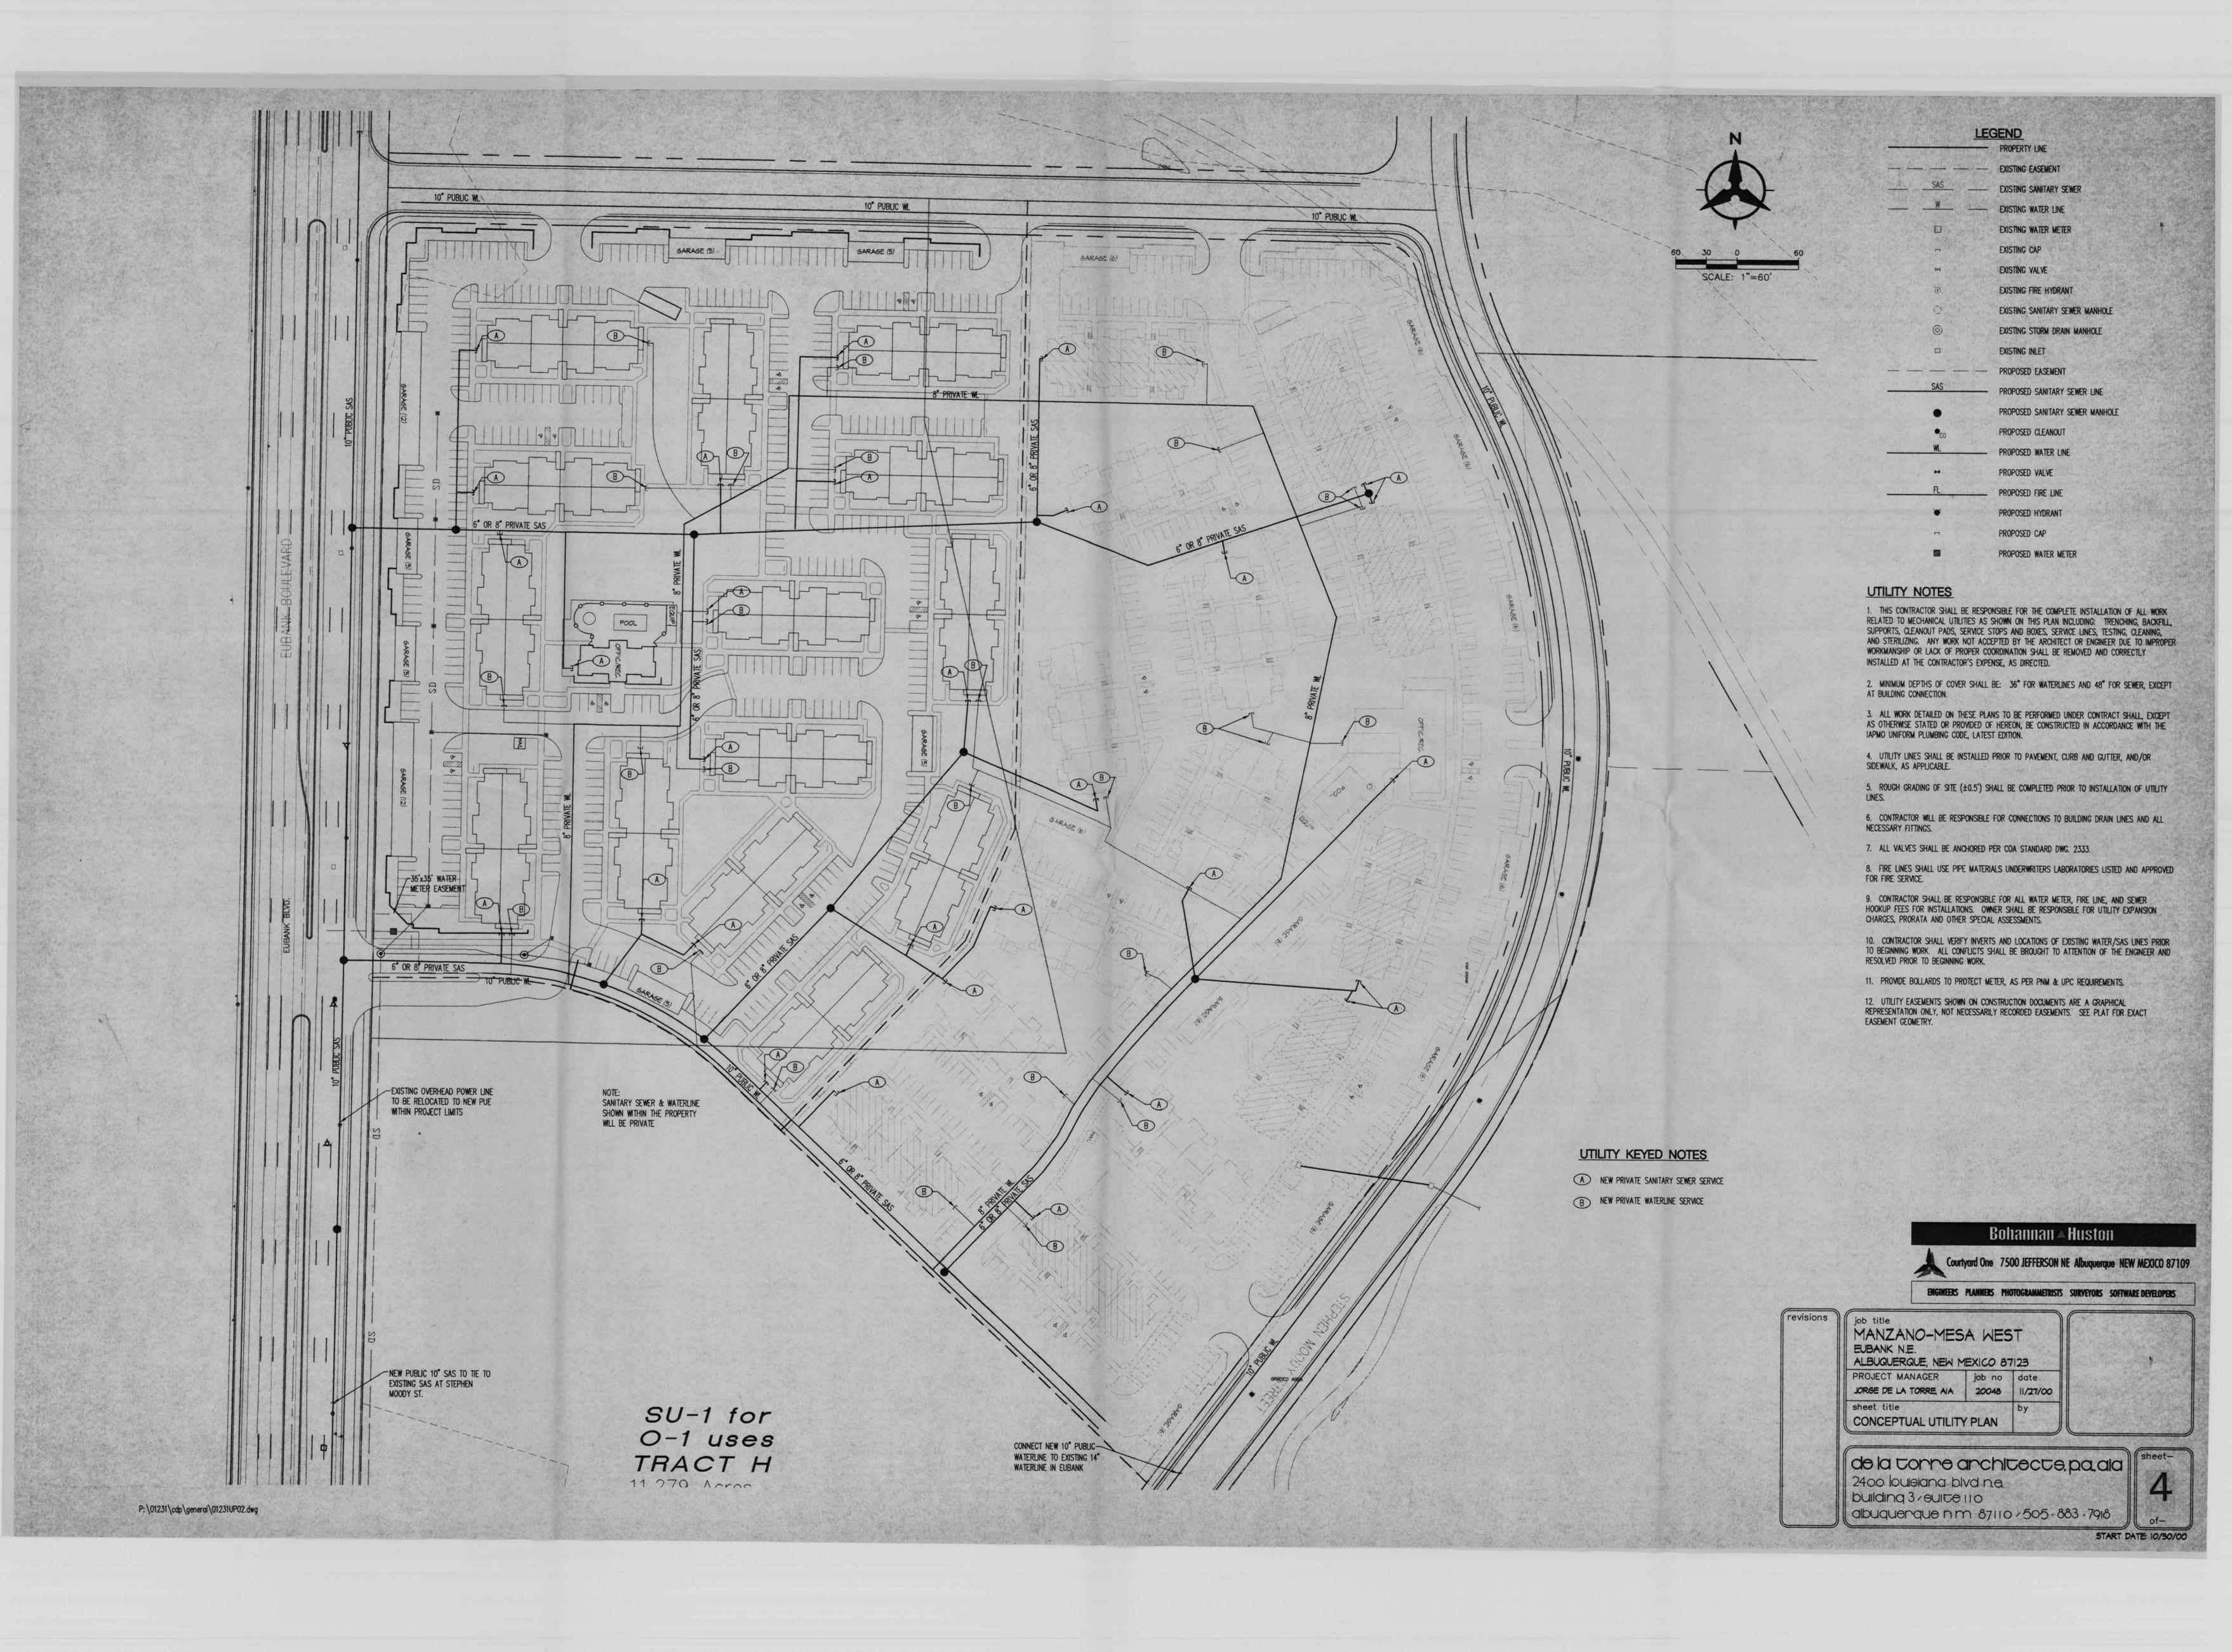
Approval of this plan does not constitute

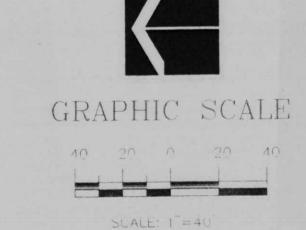
All landscaping will be in conformance with the

Plant beds shall achieve 75% live ground cover at maturity.


not designated to receive native seed.



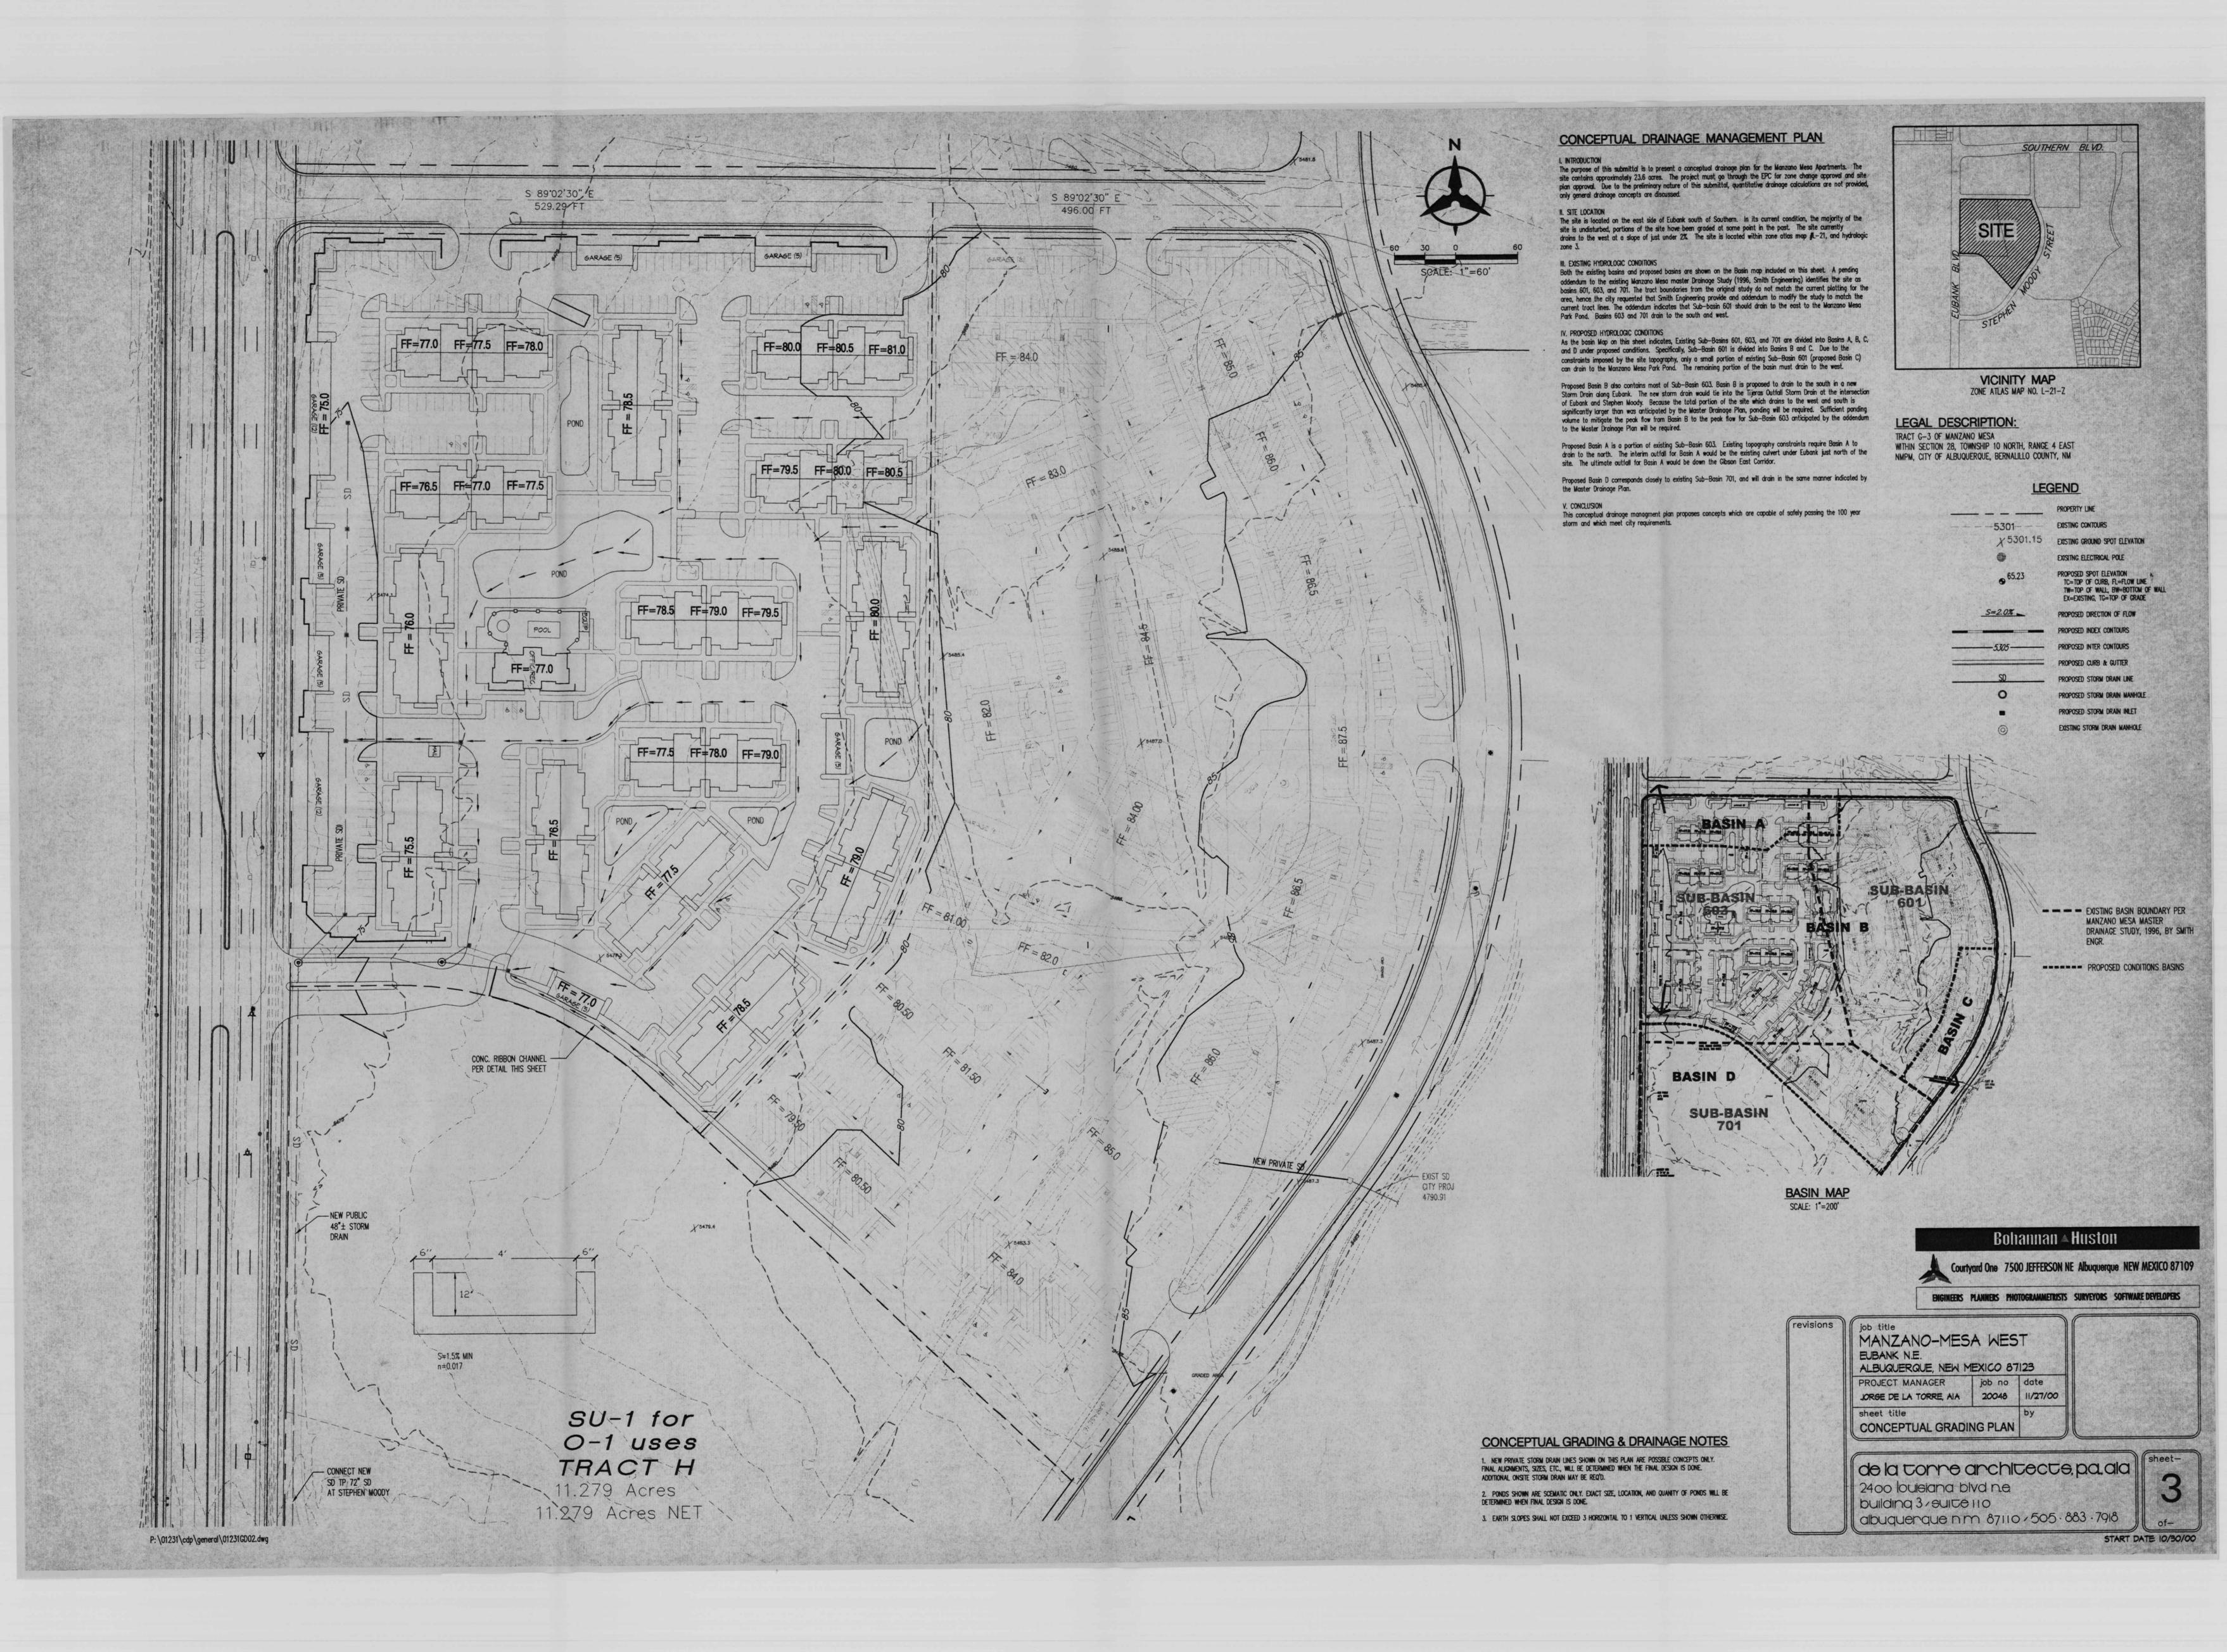

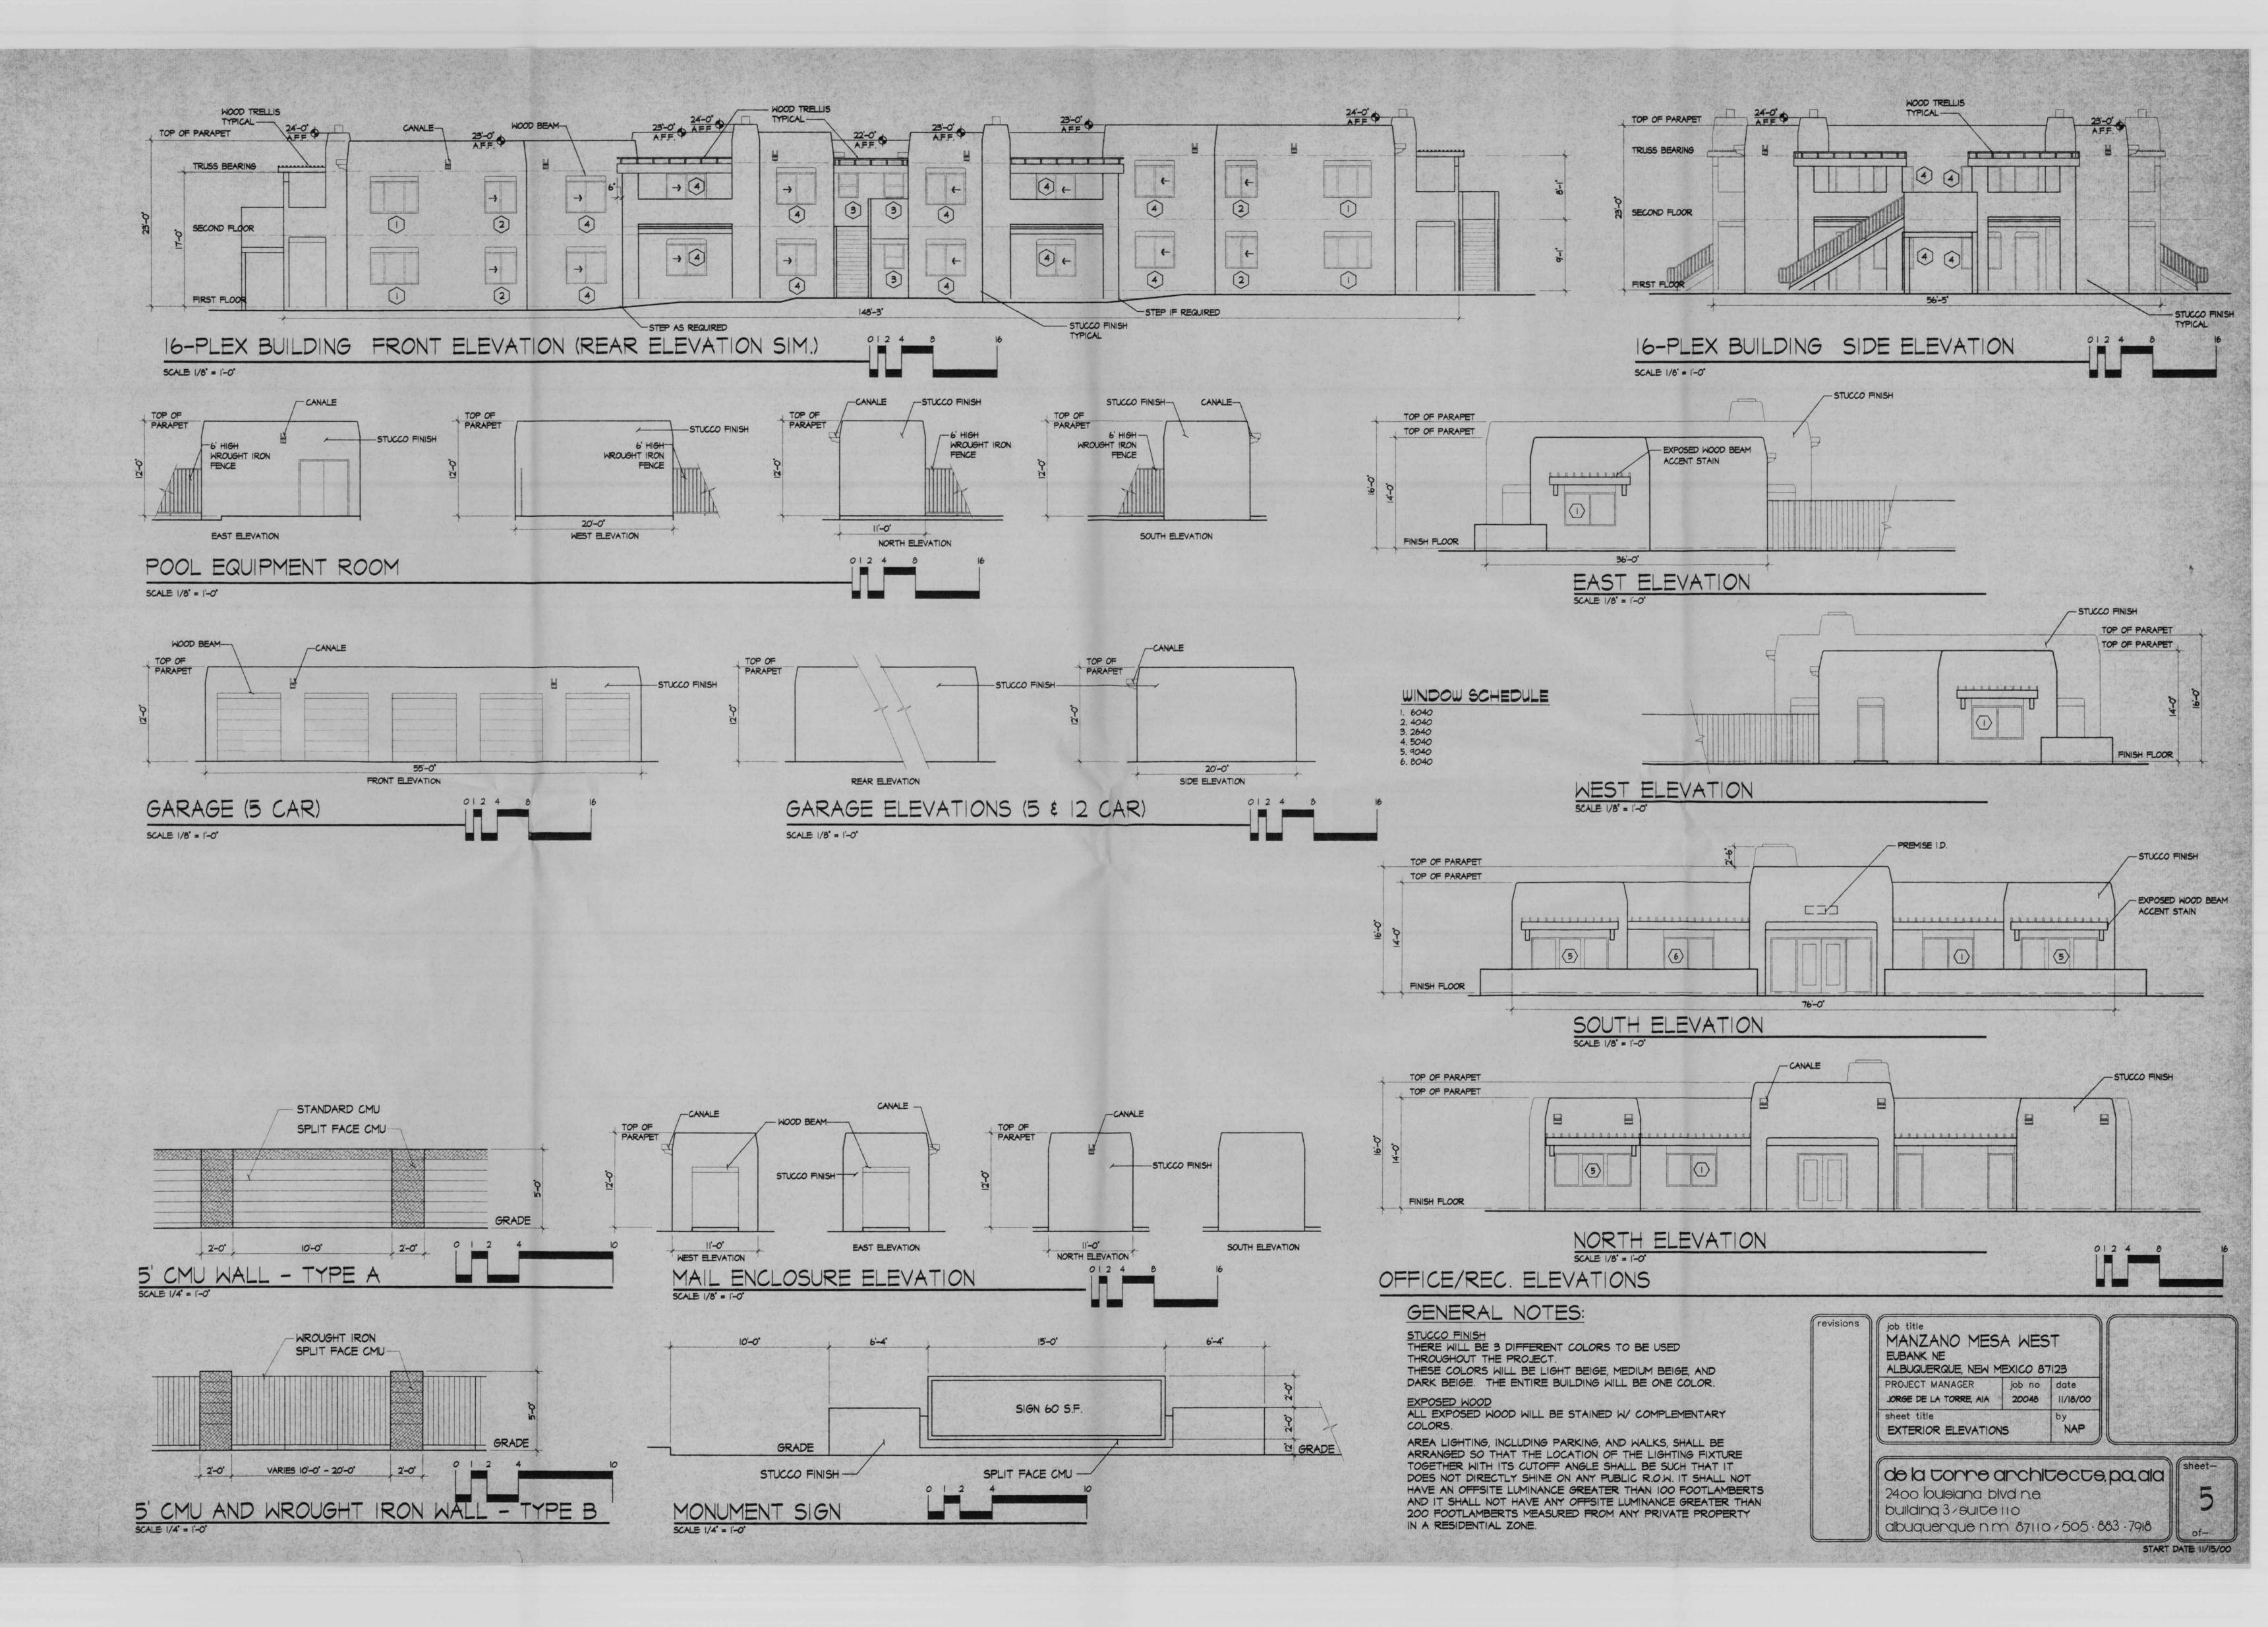

e: S./20048/Epc/ManzanoWest/manzanowest-Elevations.dwg Plotted: 2001-01-2

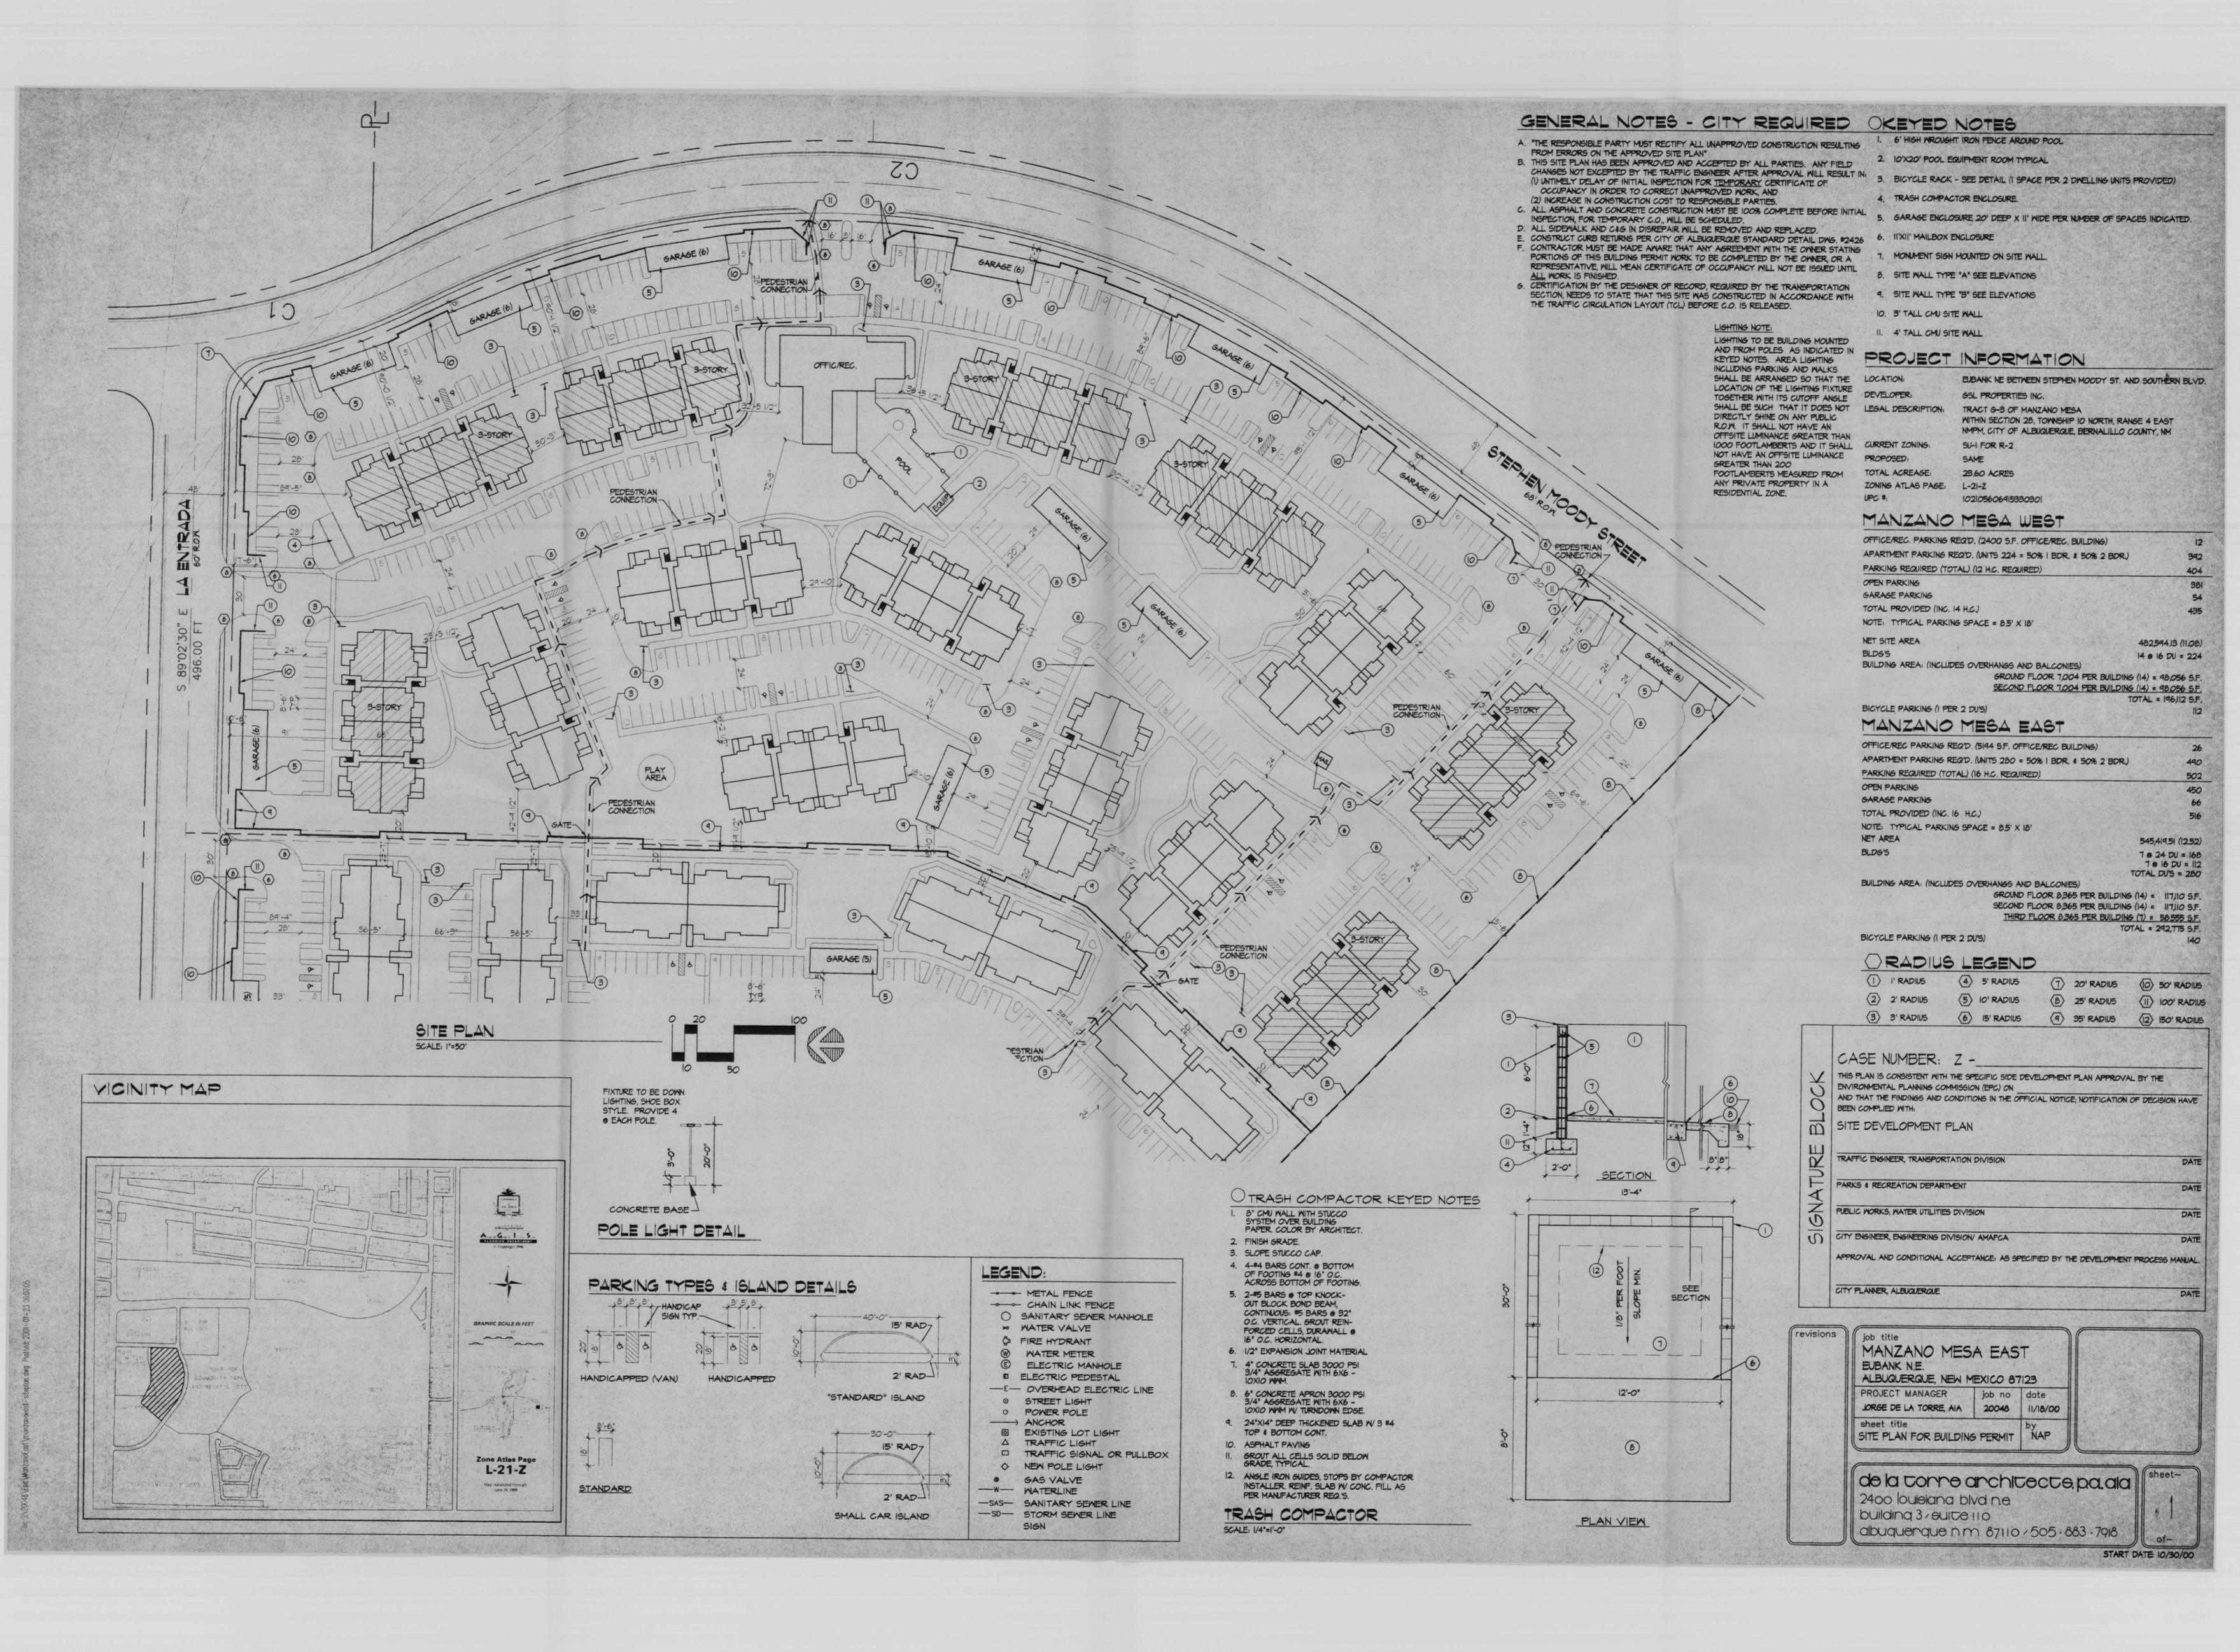





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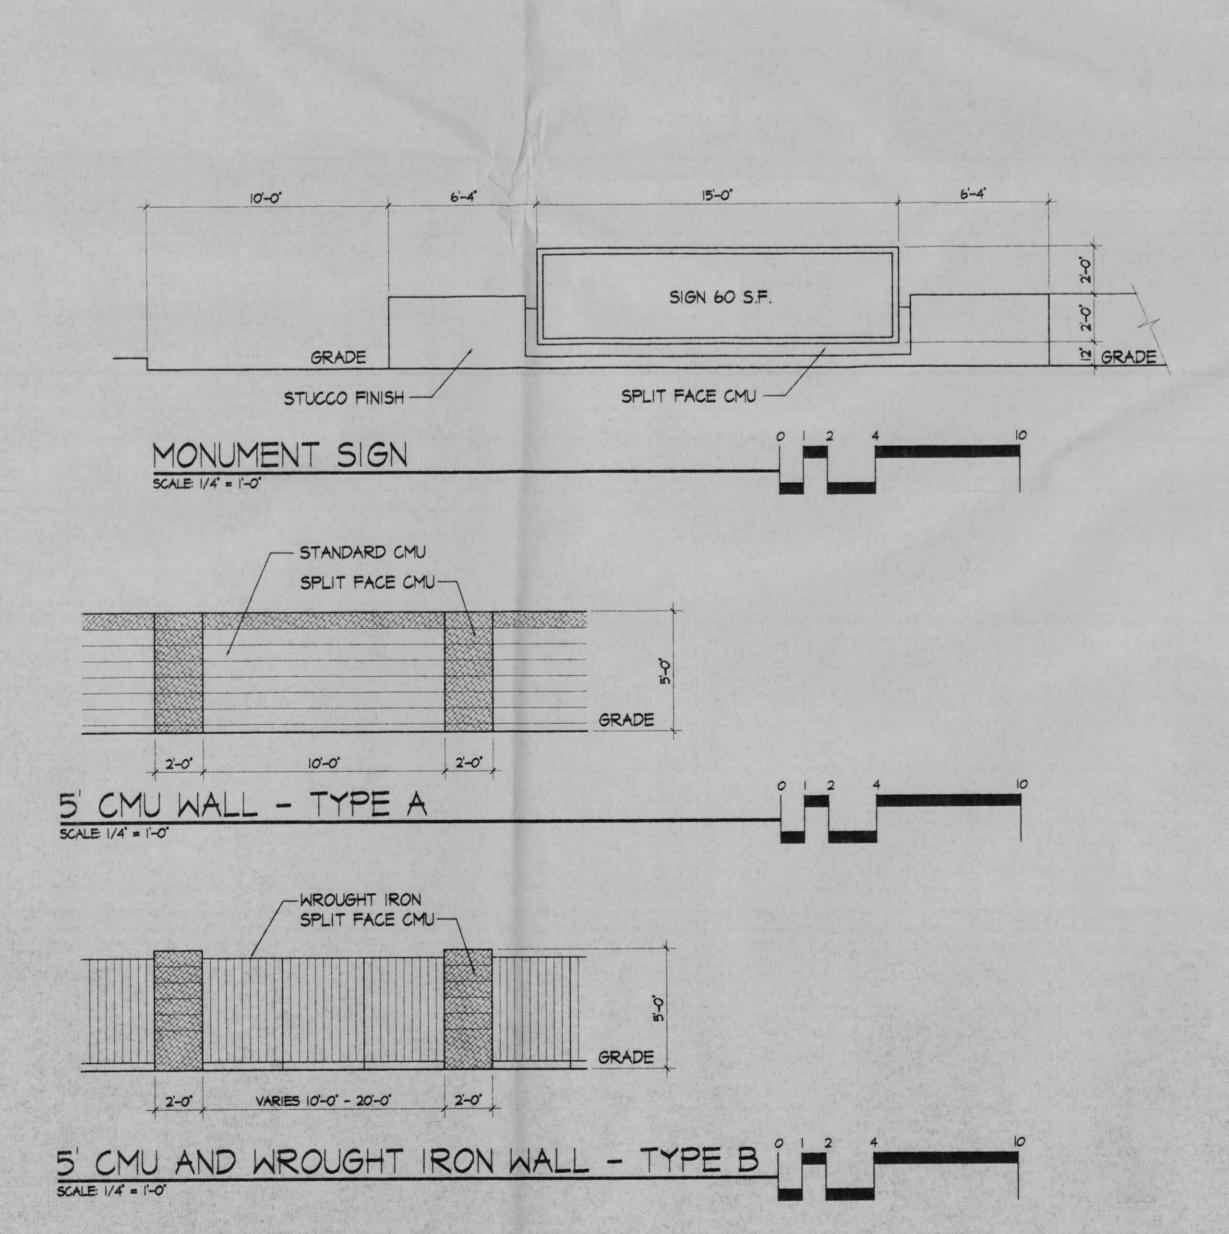





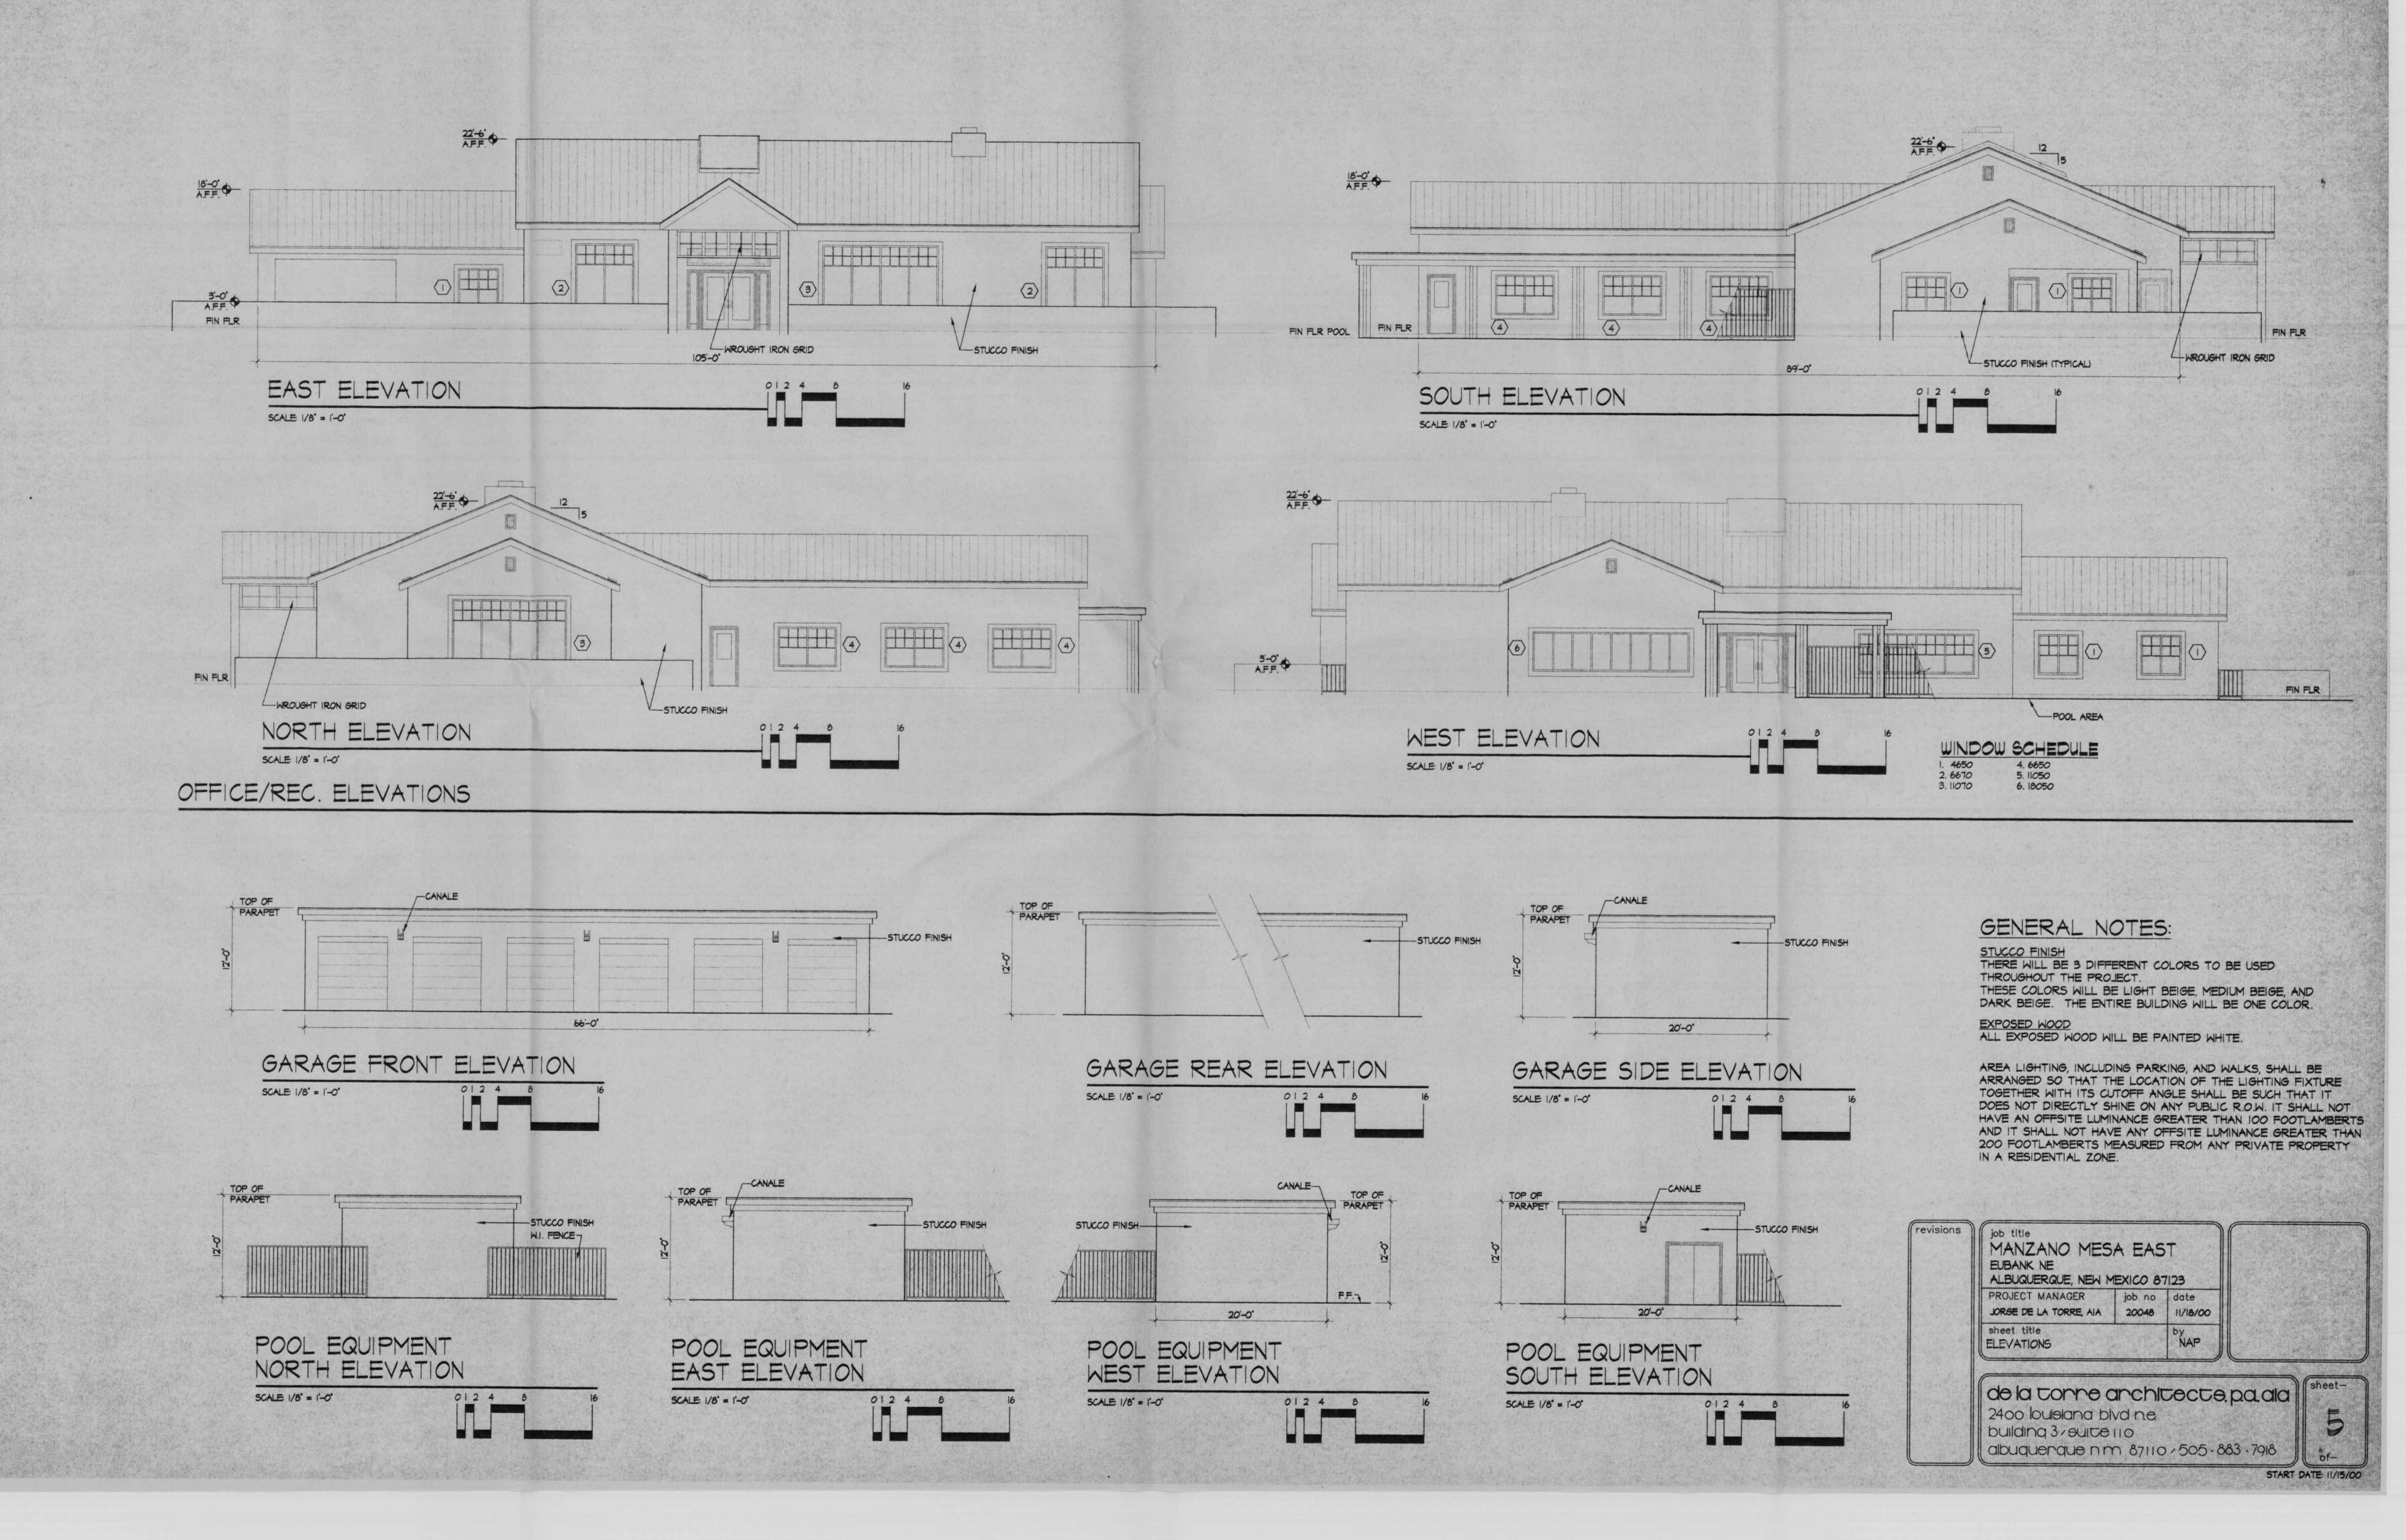


24-PLEX BUILDING - FRONT / REAR ELEVATION



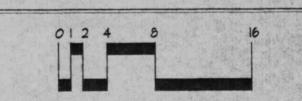

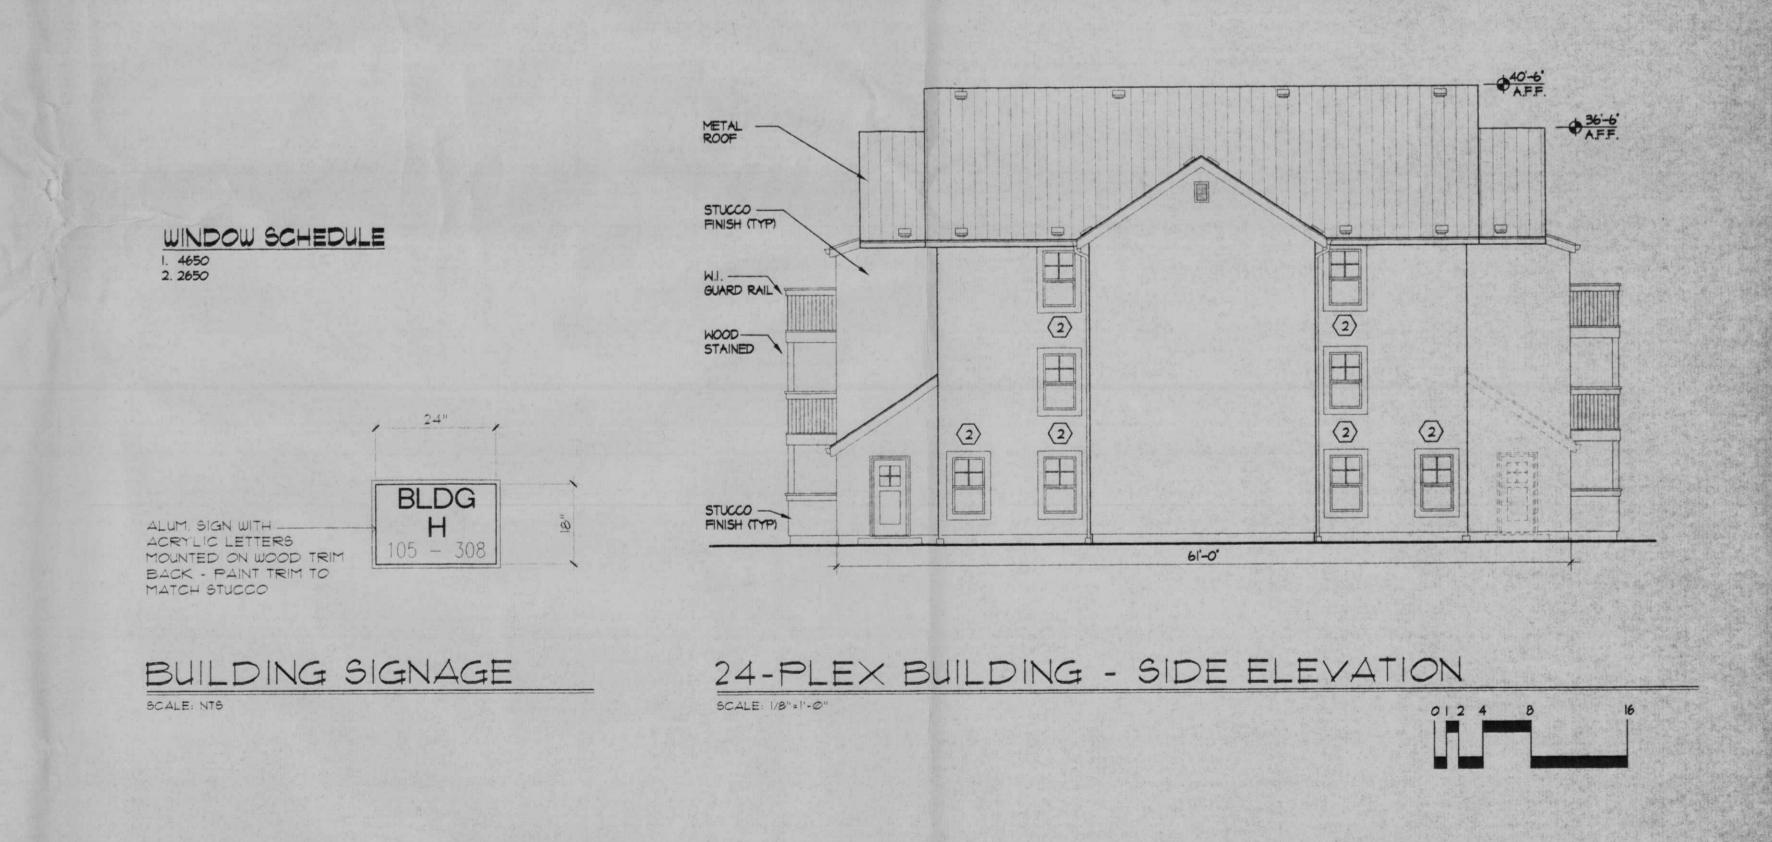

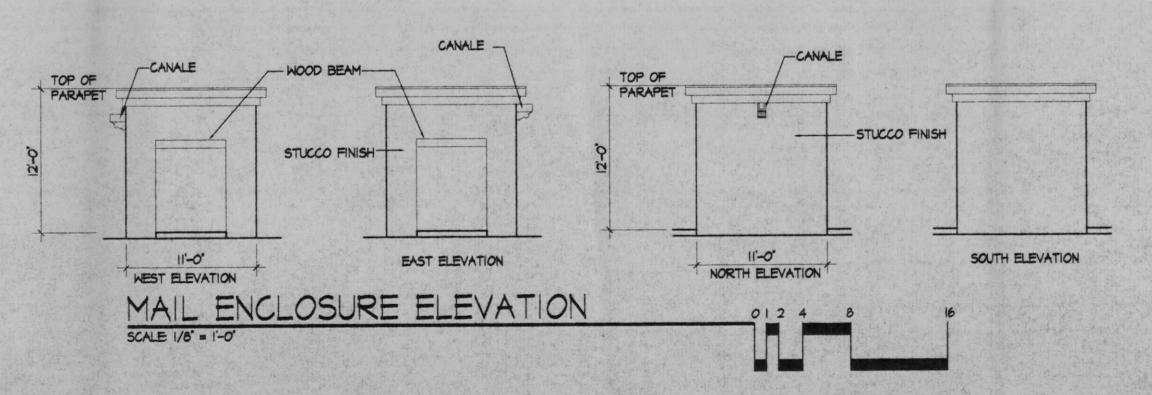



revisions

job title
MANZANO MESA EAST
EUBANK NE
ALBUQUERQUE, NEW MEXICO 87123

PROJECT MANAGER
JORGE DE LA TORRE, AIA 20048

II/18/00

sheet title
ELEVATIONS

Dy
NAP

Che la tonne anchitecte, pa, ala
2400 louisiana blvd ne
building 3 / euite 110
albuquenque n m 87110 / 505 · 883 · 7918

ofSTART DATE 11/15/00

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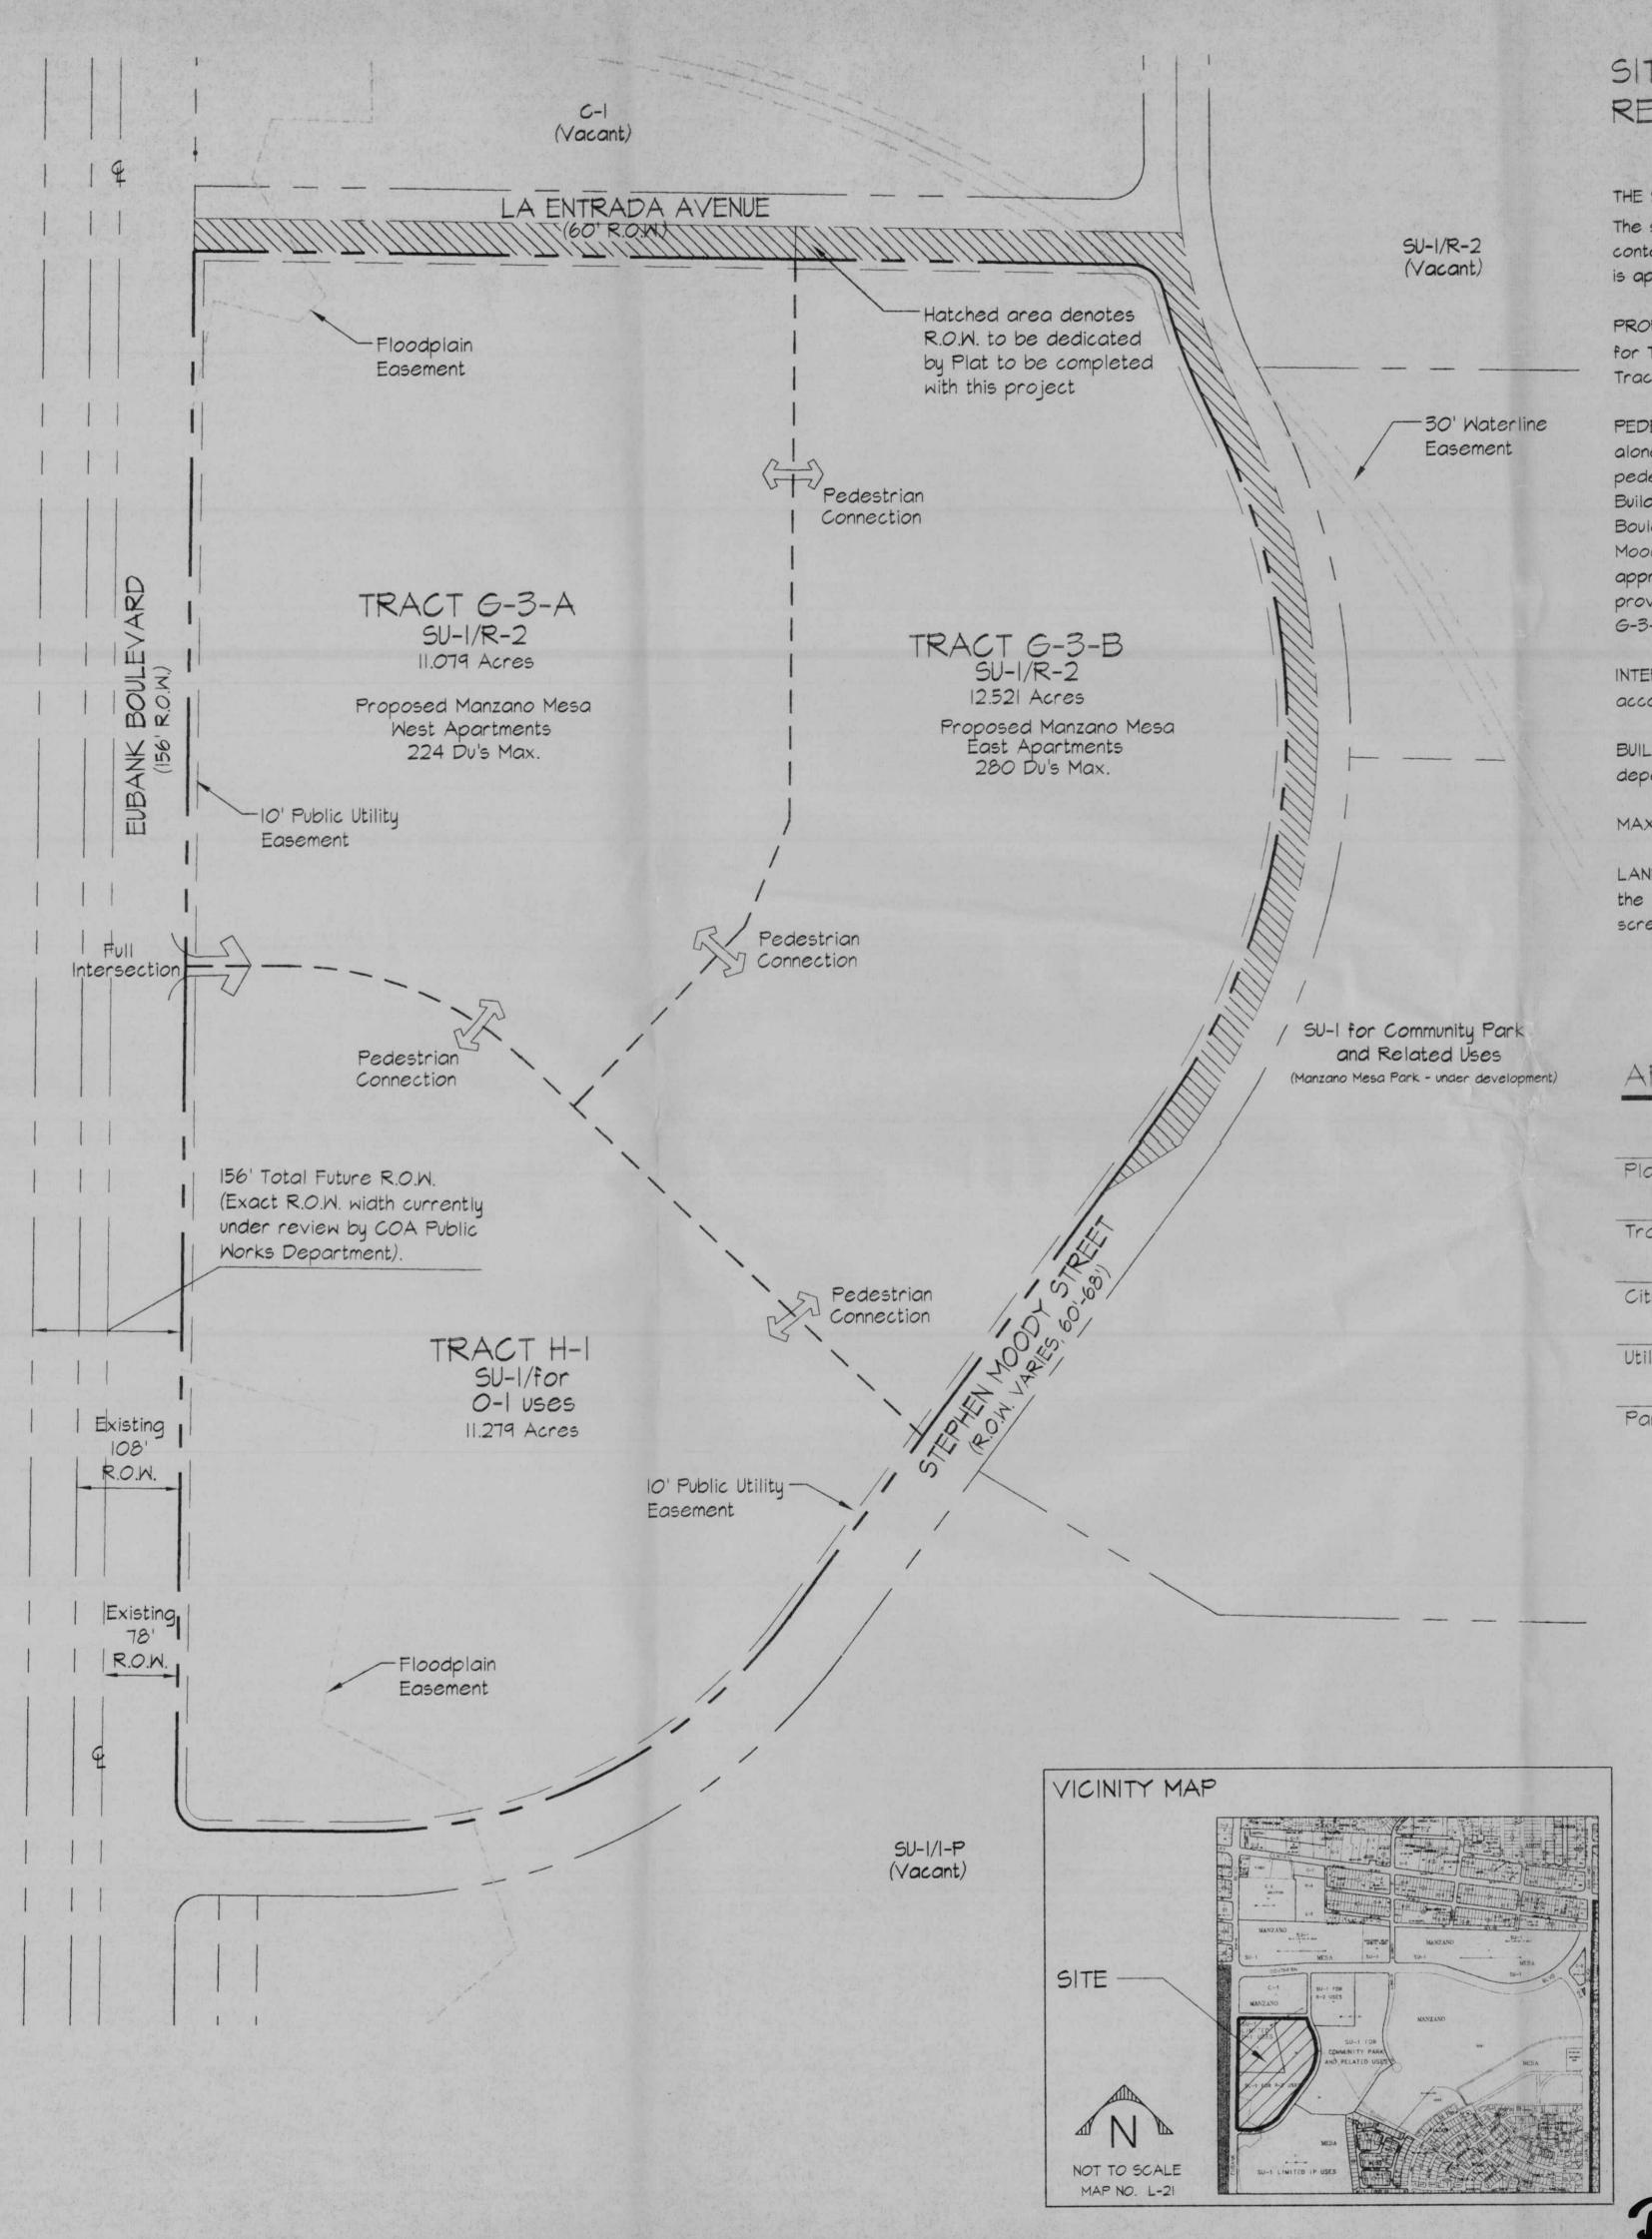
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- 27. Lighting within 100 feet of residential development shall be limited to 16 feet in height.



# SITE DEVELOPMENT PLAN FOR SUBDIVISION: REQUIRED INFORMATION

THE SITE: The site consists of 2 existing lots (Tracts H, & G3, Manzano Mesa Addition). The site shall be replatted into 3 lots. (Tracts H-1, G-3-A and G-3-B). The site contains approximately 34.9 acres. Tract H is approximately 11.3 acres, Tract G-3-A is approximately 11.0 acres, and Tract G-3-B is approximately 12.6 acres.

PROPOSED USE: The zoning for tract H (H-1) shall remain SU-1 for O-1 uses. The zoning for Tract G-3 (G-3-A and G-3-B) shall remain SU-1 For R-2. The proposed use for Tracts G-3-A and G-3-B is multi-family residential.

PEDESTRIAN AND VEHICULAR INGRESS AND EGRESS: There will be a 6 foot sidewalk along Eubank Boulevard, Stephen Moody Street, and La Entrada Avenue. Interior pedestrian ways shall be developed in accordance with the individual Site Plans for Building Permit. There is a proposed multi-use trail adjacent to the site along Eubank Boulevard. The primary access to Tracts H-1 and G-3-B shall be off of Stephen Moody Street. A cul-de-sac will be developed from Eubank Boulevard at the approximate midpoint between Stephen Moody Street and La Entrada Avenue to provide access to Tracts H-I and G-3-A. Secondary access to Tracts G-3-A and G-3-B will be provided off of La Entrada Avenue.

INTERNAL CIRCULATION REQUIREMENTS: Internal circulation shall be developed in accordance with the individual Site Plans for Building Permit.


BUILDING HEIGHTS AND SETBACKS: Pursuant to the R-2, or O-1 zoning, as appropriate depending on the specific land use.


MAXIMUM F.A.R.: Maximum F.A.R. shall be .35.

LANDSCAPE PLAN: Detailed Landscape Plans shall be developed in accordance with the individual Site Plans for Building Permit and consistent with these landscaping and screening requirements.

# APPROVALS

Planning Director	Date
Transportation Development	Date
City Engineer/AMAFCA	Date
Utility Development	Date
Parks and Recreation Department	Date

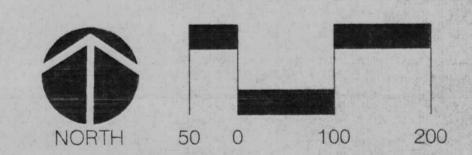


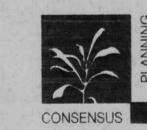


CONSENSUS PLANNING, INC. 924 Park Avenue SW (505) 764-9801 Fax 842-5495 CONSENSUS e-mail: cp@consensusplanning.com




Proj. 1000938

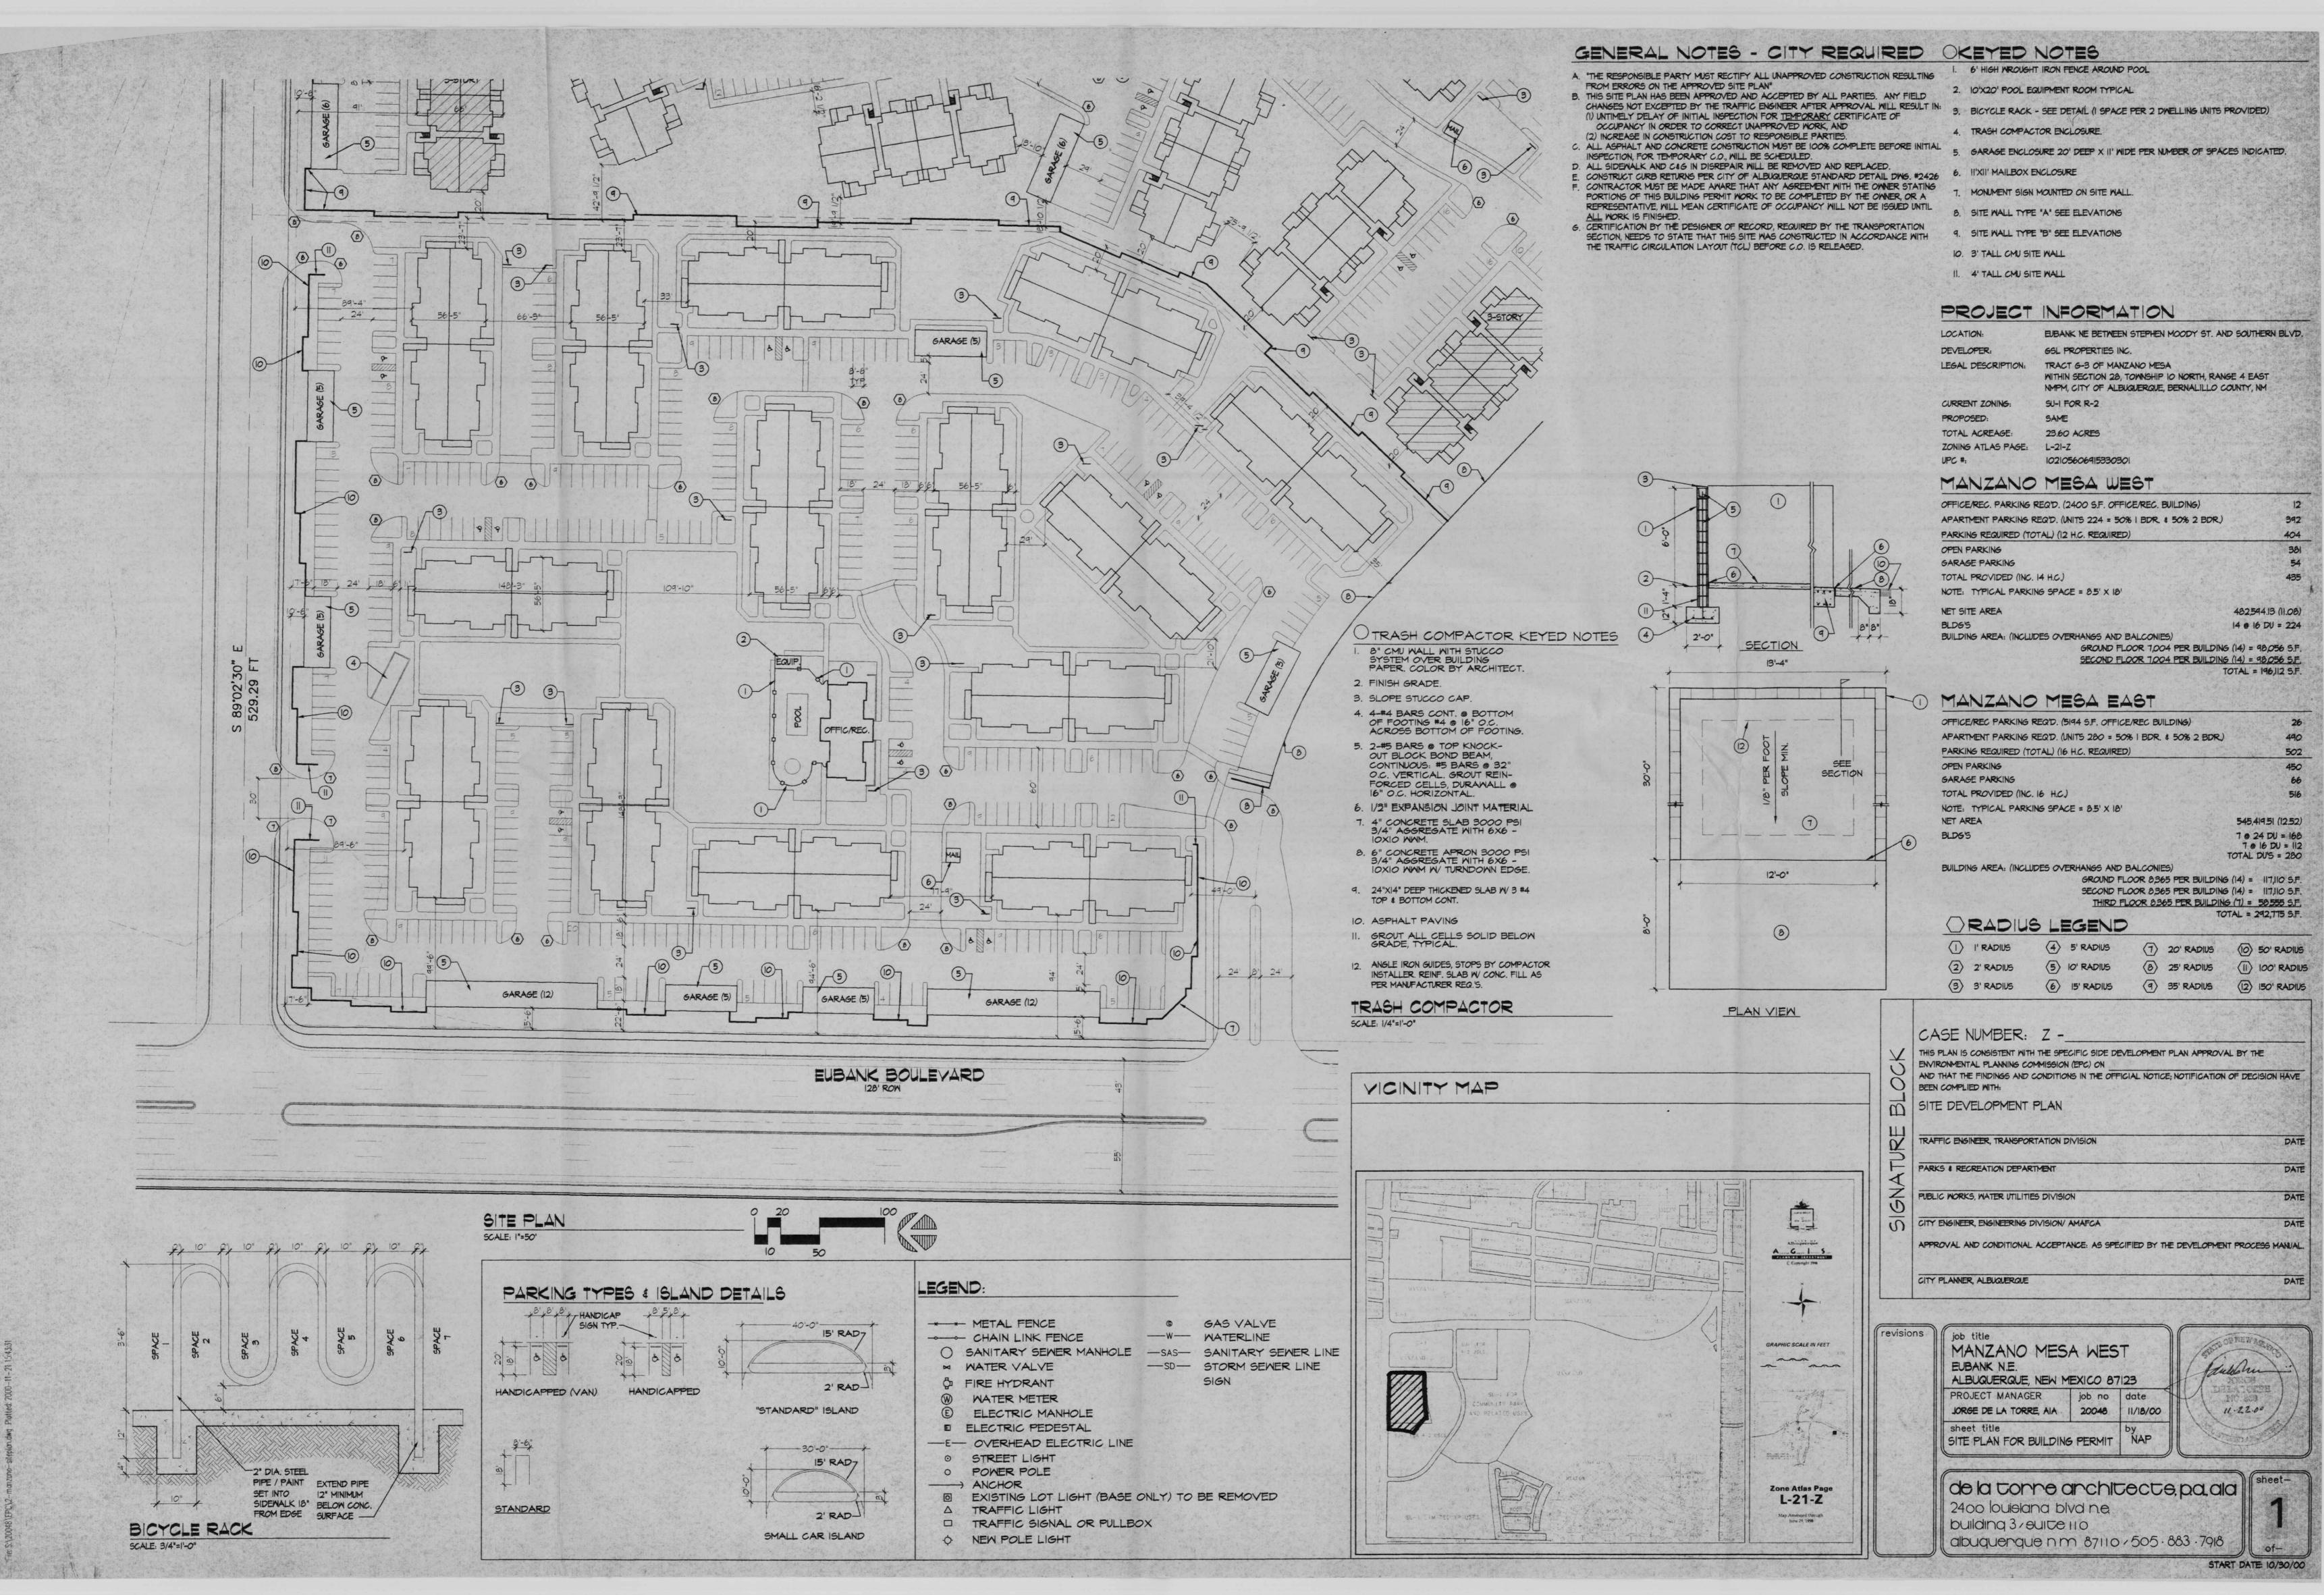

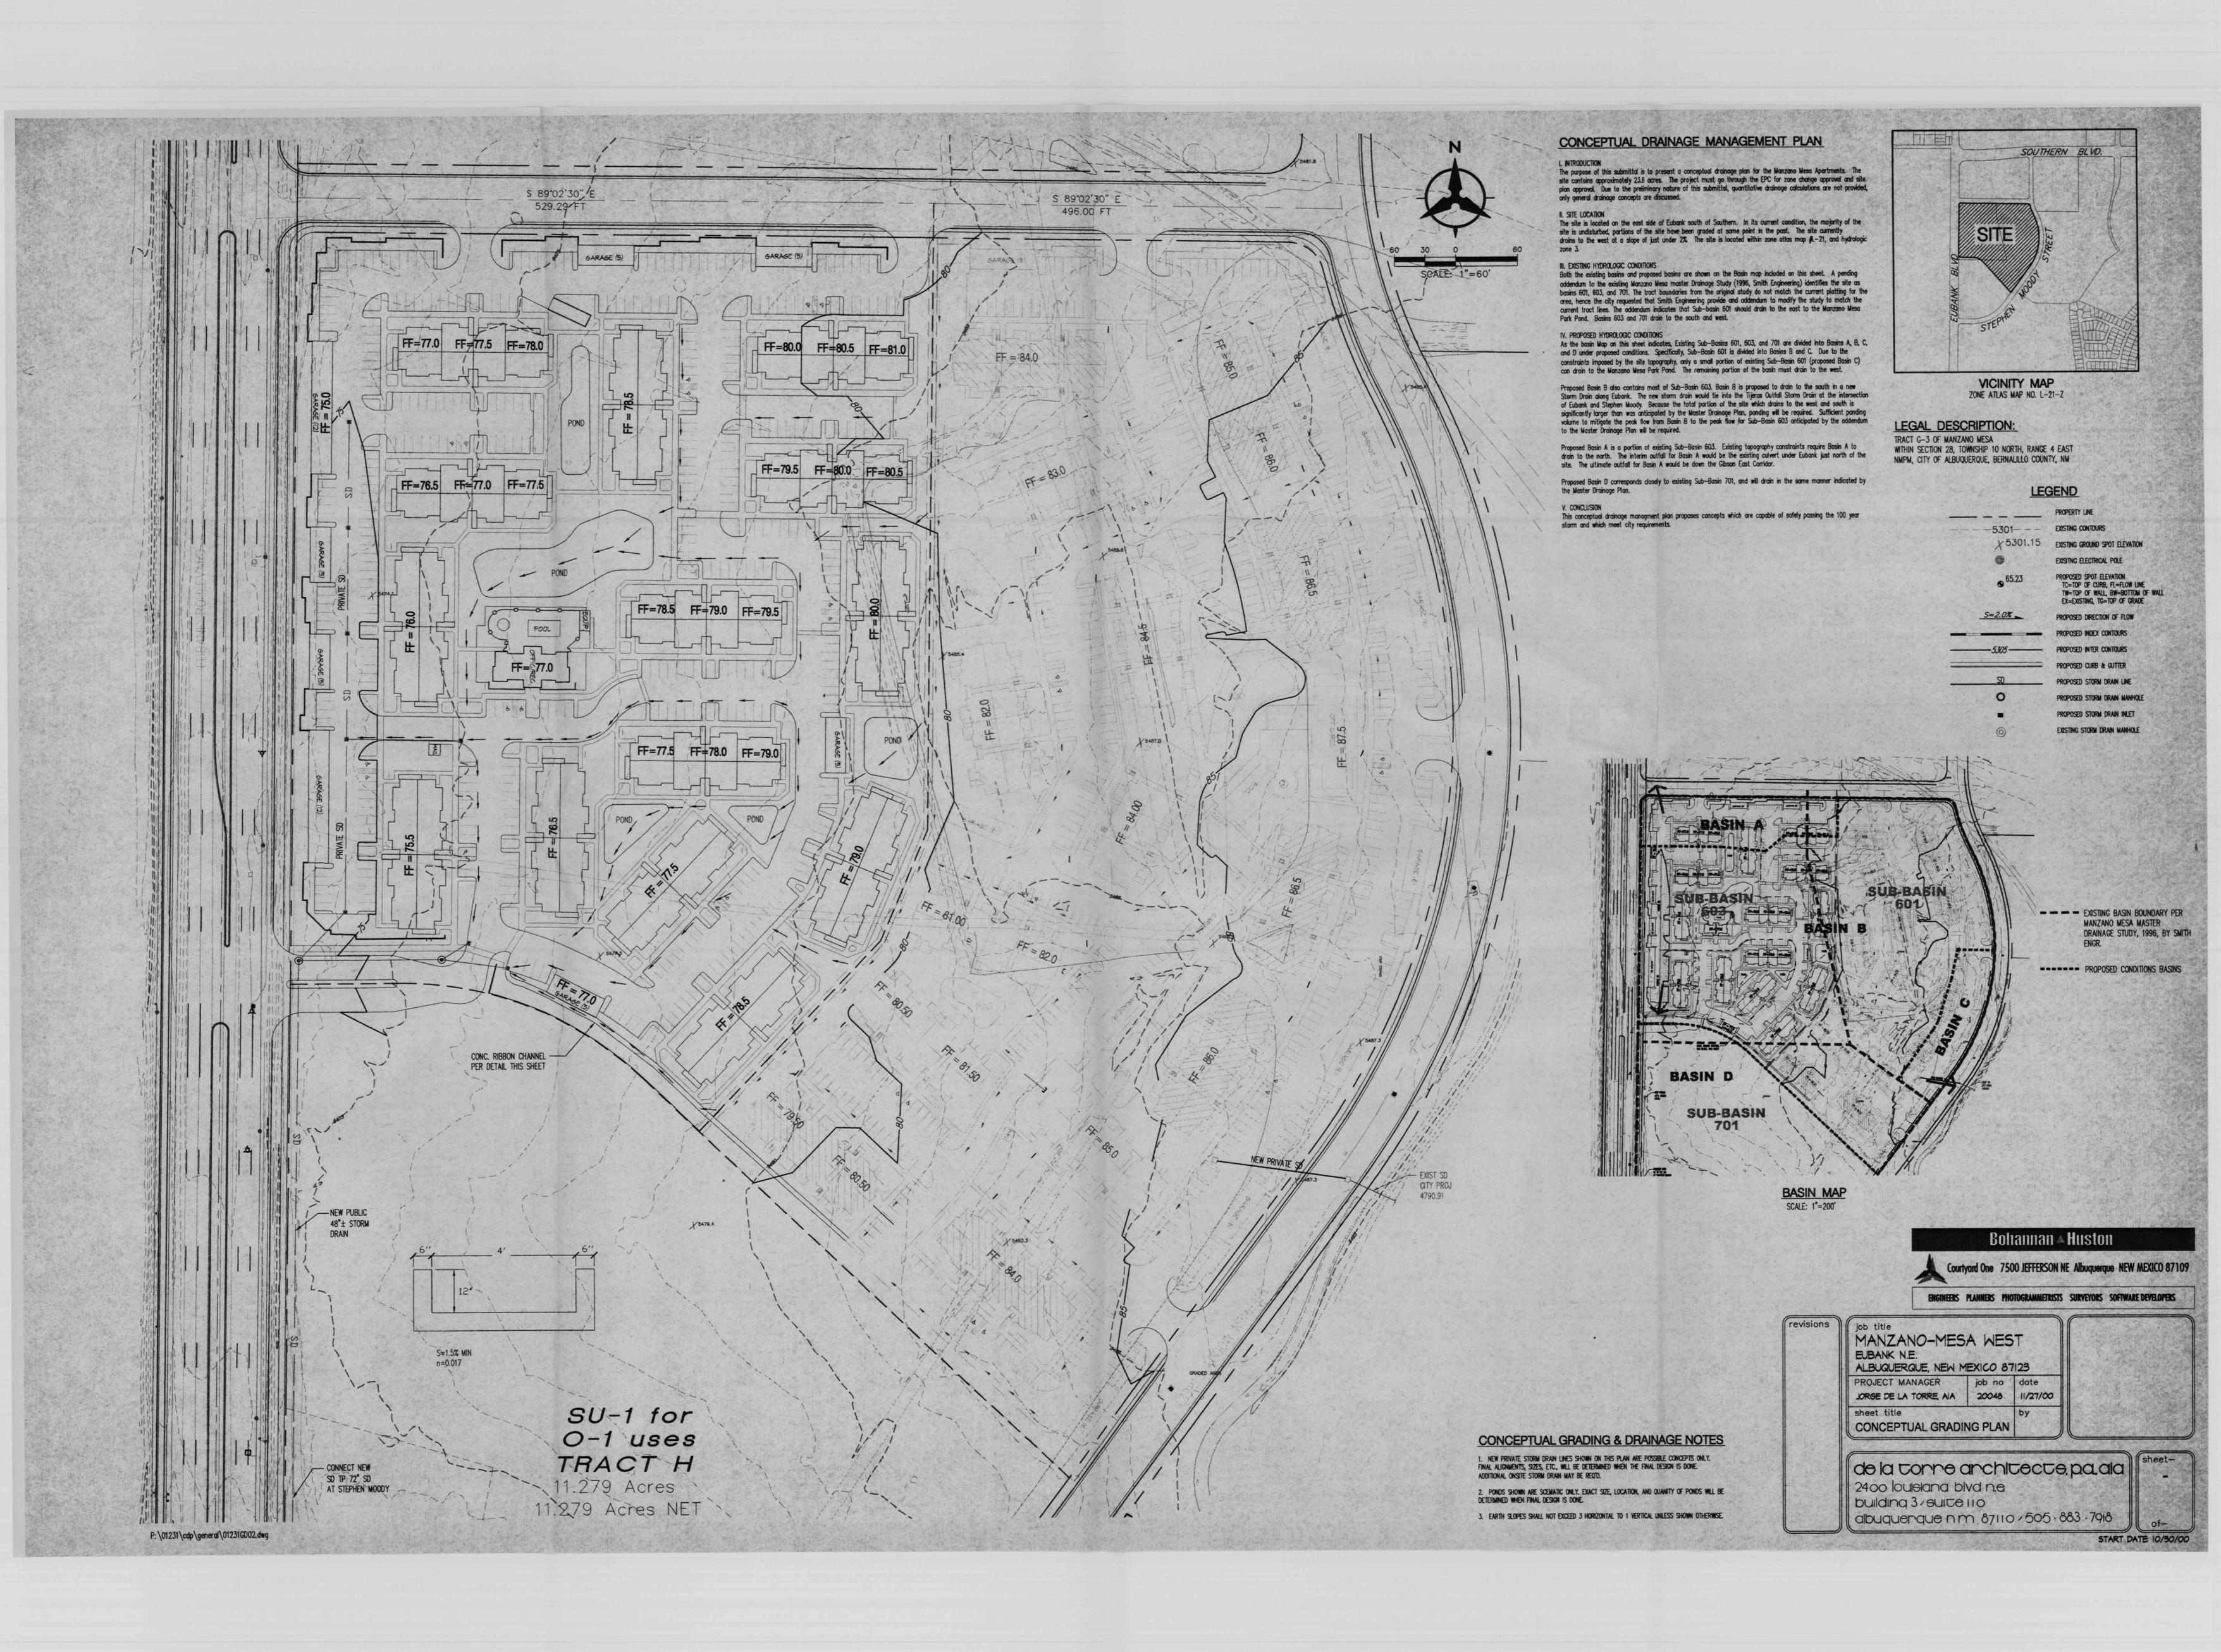



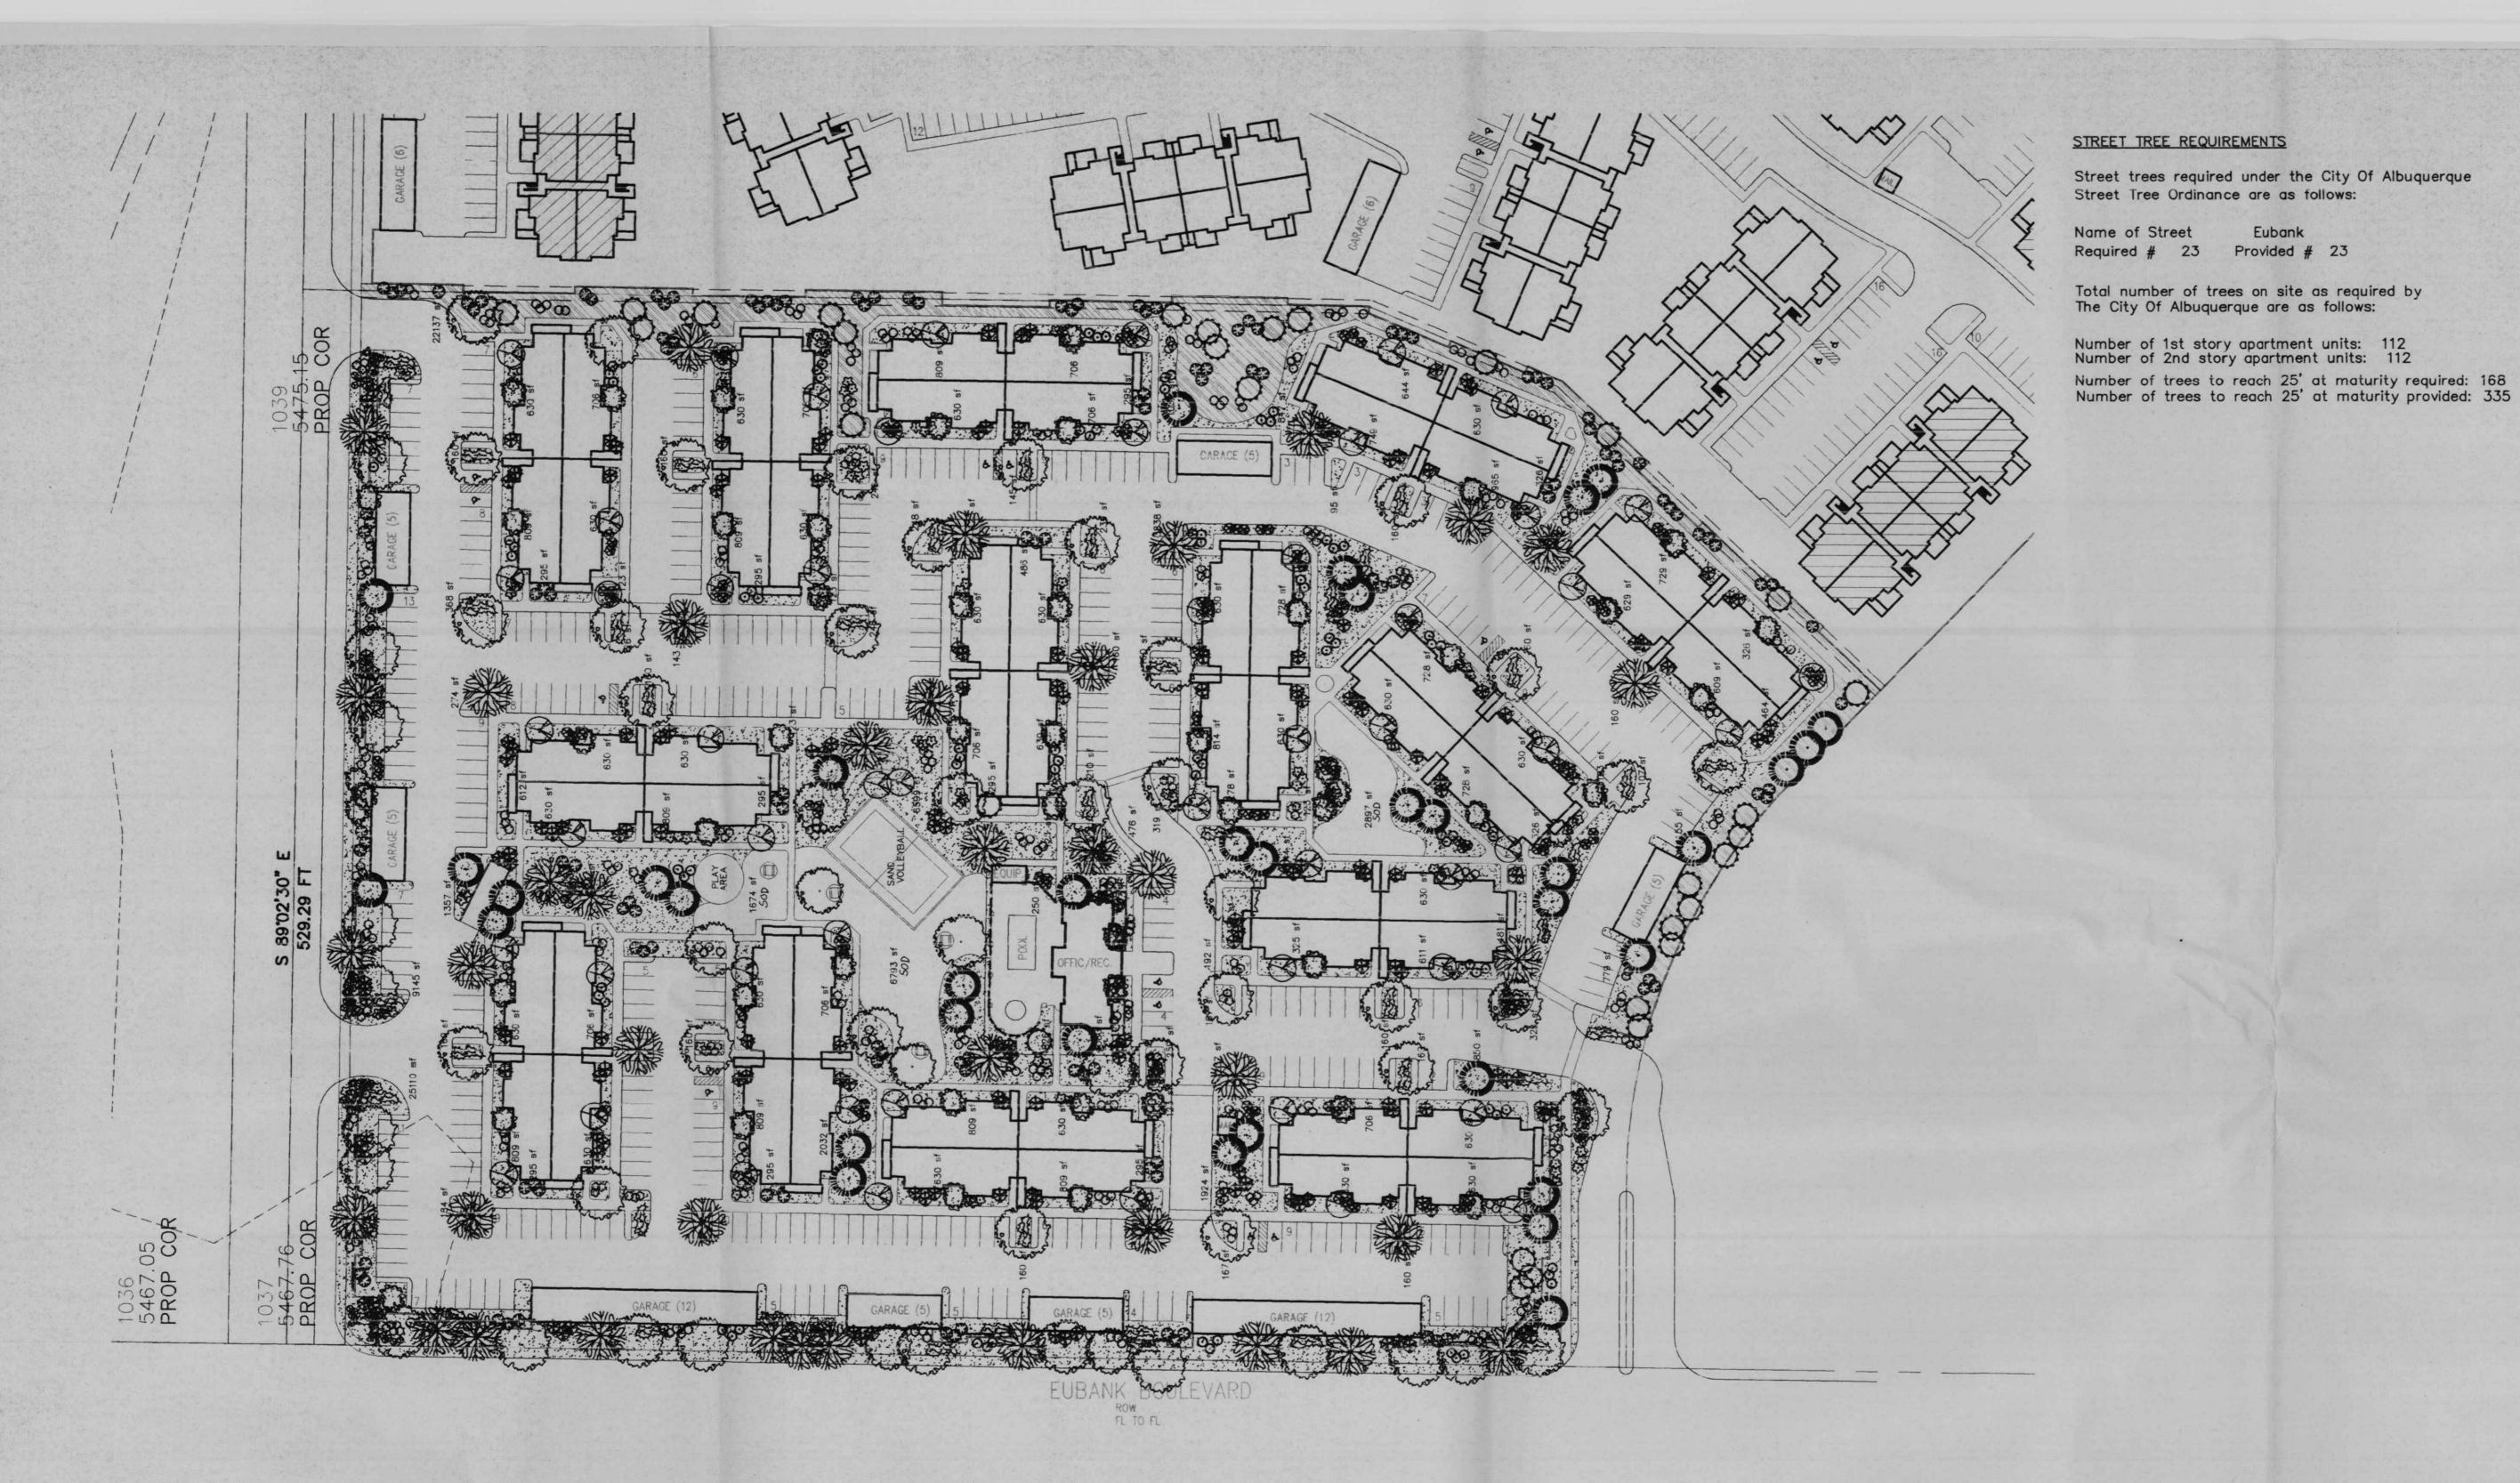

# LANDSCAPE CALCULATIONS

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TOTAL BUILDINGS AREA	100,237	square	feet
OFFSITE AREA	0	square	feet
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TOTAL SOD PROVIDED	11364 (20%)	square	feet
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LANDSCAPE NOTES:

Landscape maintenance shall be the responsibility of the Property Owner.

It is the intent of this plan to comply with the City Of Albuquerque, Water Conservation Landscaping and Water Waste Ordinance, planting restriction approach.

Approval of this plan does not constitute or imply exemption from water waste provisions of the Water Conservation Landscaping and Water Waste Ordinance. Water management is the sole responsibility of the Property Owner.

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GPH Drip Emitters. Drip and Bubbler systems to be tied to 1/2" polypipe with flush caps at each end.

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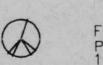
PLANT LEGEND




SHADE TREE 59
RAYWOOD ASH (H) Fraxinus oxycarpa raywood
ARIZONA ASH (H)
Fraxinus velutina 2" Cal



SHADE TREE 40
THORNLESS HONEYLOCUST
Gleditsia triacanthos 'inermis' 2" Cal



FLOWERING PEAR (H) 53

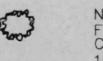


NEW MEXICO OLIVE/WASHINGTON HAWTHORN(M)54
Forestiera neomexicana
Crateagus phaenopyrum 15 Gal.



DESERT WILLOW (L) 31 Chilopsis linearis 15 Gal.

AUSTRIAN PINE (H) 36



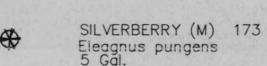

INDIAN HAWTHORN (M) 110 Raphiolepis indica 5 Gal.

RUSSIAN SAGE (M) 93
Perovskia atriplicifolia
5 Gal.

APACHE PLUME (L) 186 Eallugia paradoxa

AUTUMN SAGE (M) 141


PROSTRATE ROSEMARY (M) 110
Romarinus officianalis 5 gal

CHAMISA (L) 133 Chrysothamnus nauseosus 1 Gal.

WILDFLOWER 52 1 Gal.

TAM JUNIPER (M) 150 Juniperus sabina 5 Gal.

BOSTON IVY 51 Parthenocissus tricuspidata

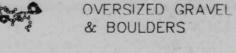

3/4" SANTA ANA TAN GRAVEL WITH FILTER FABRIC

SOD

CRIMP STRAW NATIVE SEED



COMMERCIAL GRADE STEEL EDGING

POP-UP SPRINKLER HEADS

LANDSCAPE ARCHITECTS & CONTRACTORS Cont. Lic. #26458 7909 Edith N.E. Albuquerque, NM 87184 Ph. (505) 898-9690 Fax (505) 898-7737 it@hilltoplandscaping.com

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(revisions | (job title MANZANO-MESA APTS. EUBANK N.E. ALBUQUERQUE, NEW MEXICO 87123 job na date PROJECT MANAGER JORGE DE LA TORRE, AIA 20048 11/1/00 sheet title

> de la tonne anchitects, palaia 2400 louisiana biva n.e.


GRAPHIC SCALE

SCALE: 1"=40"

building 3 suite 110


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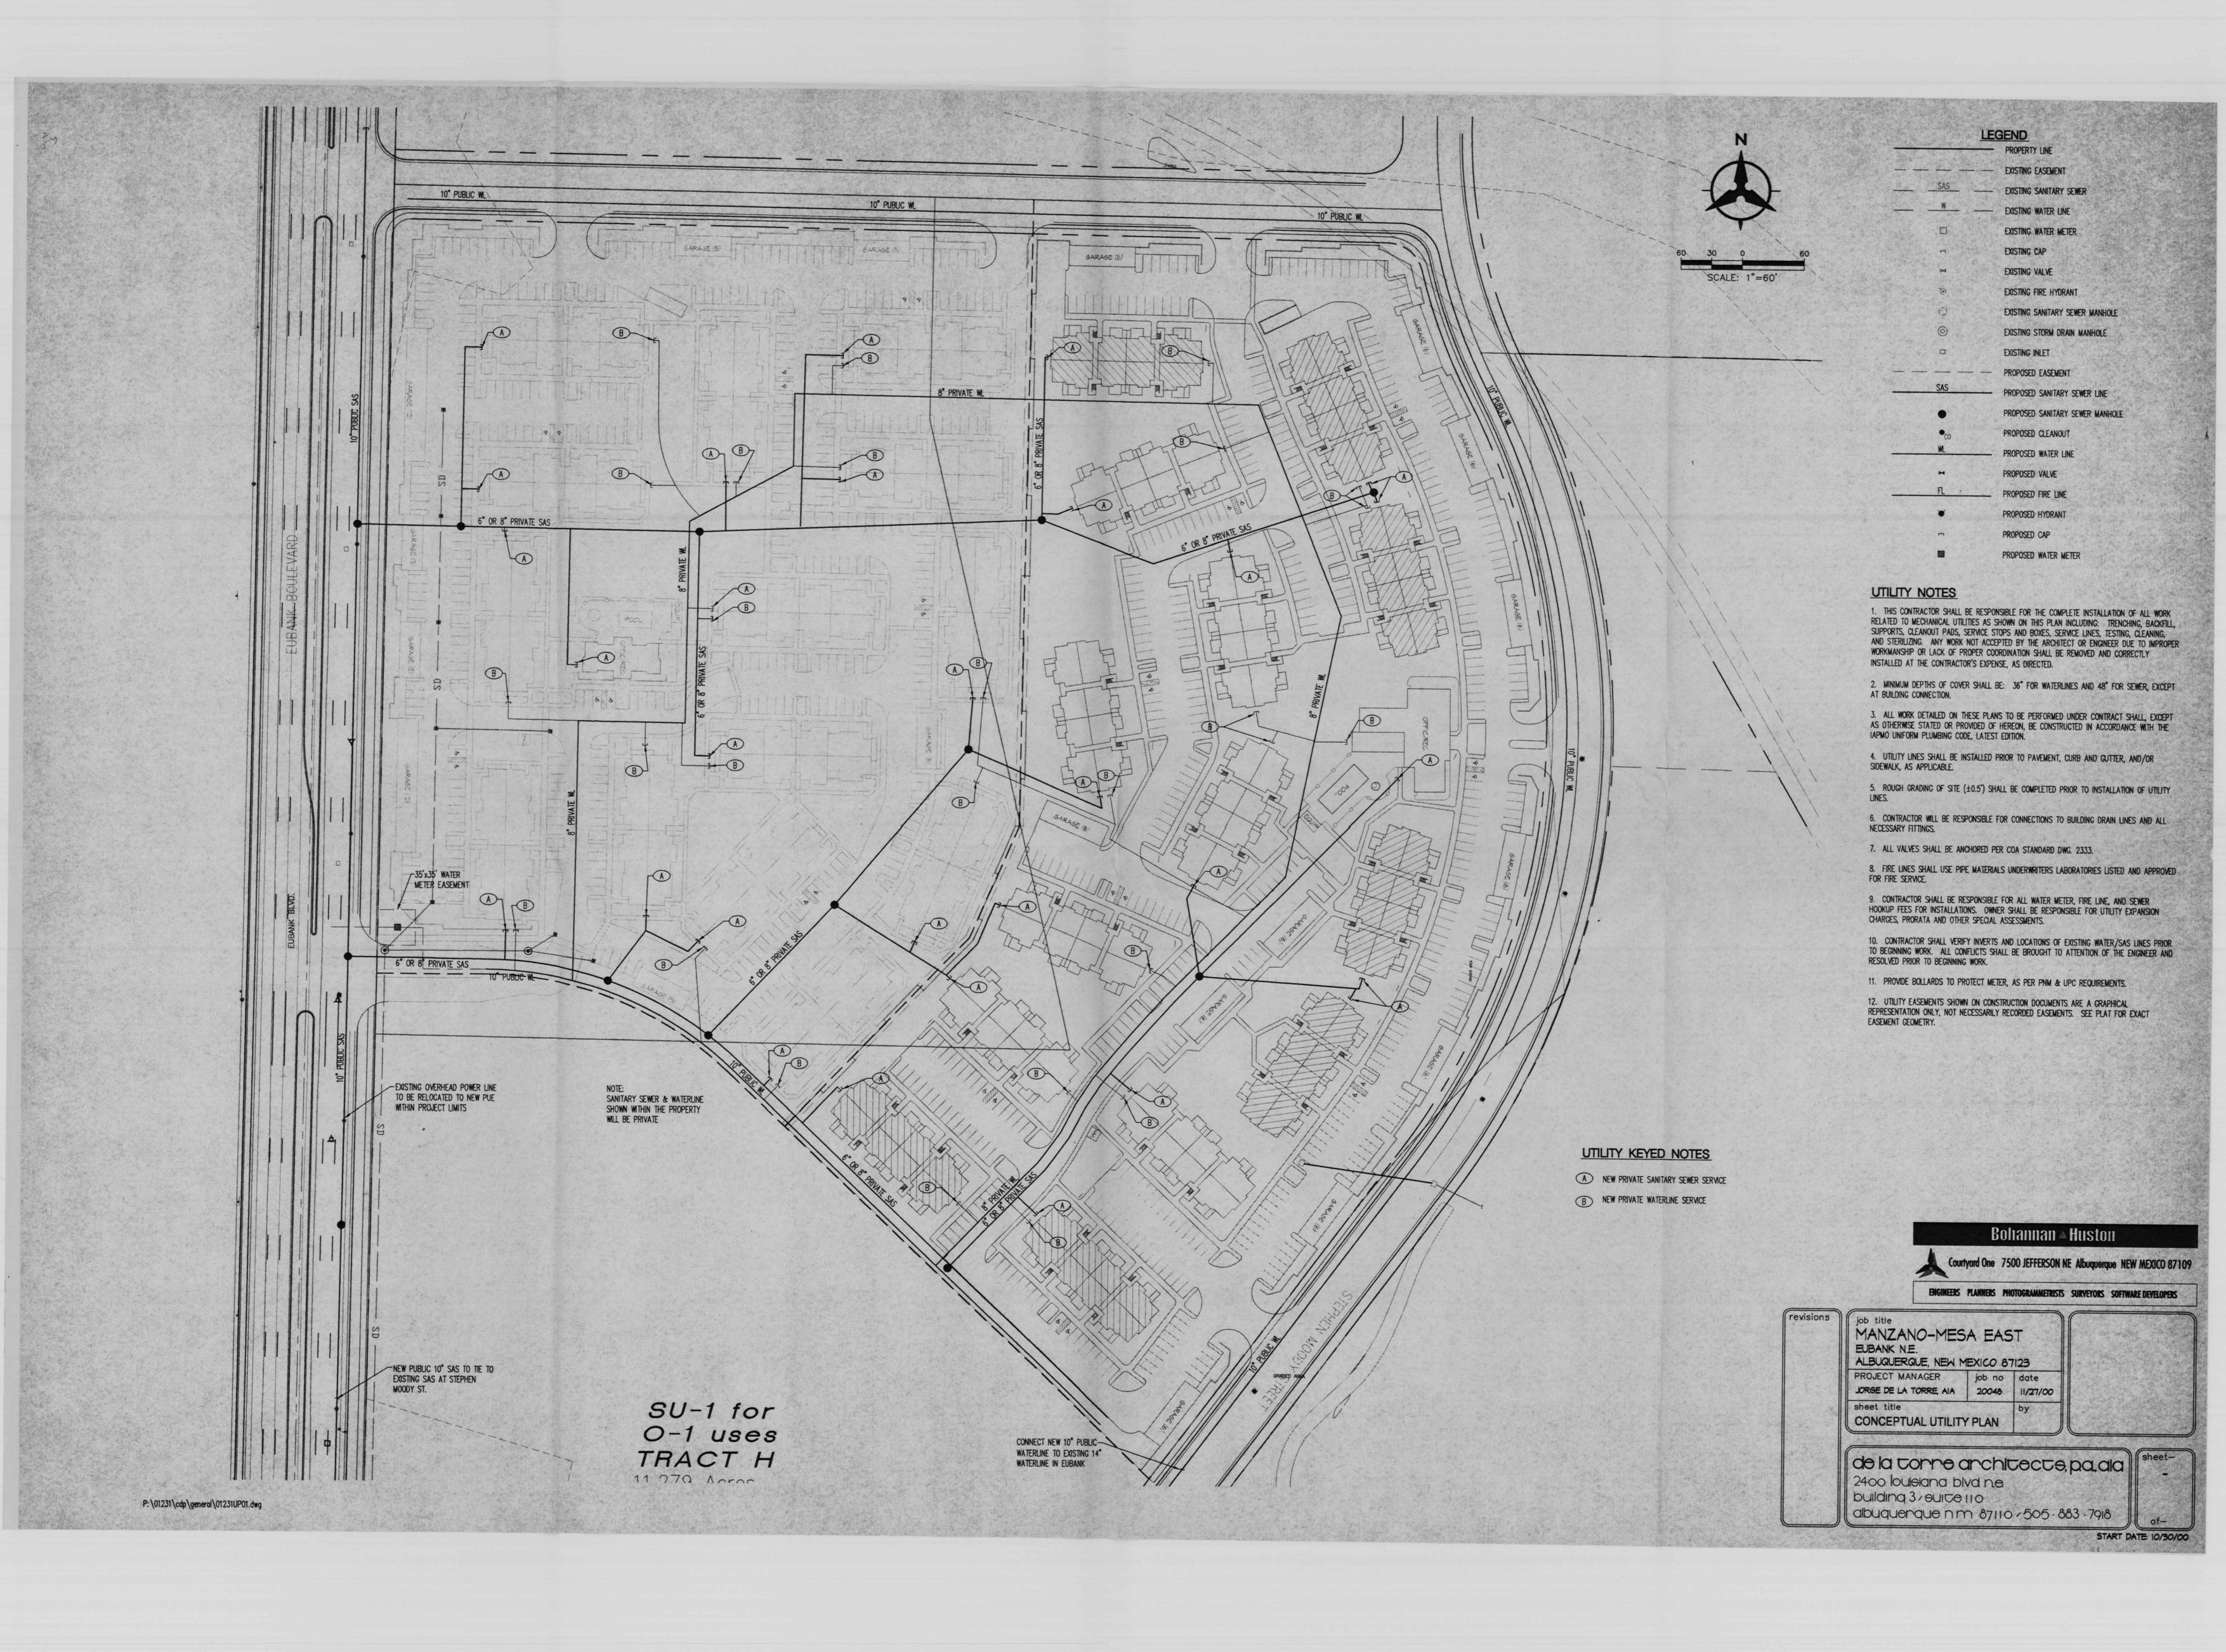
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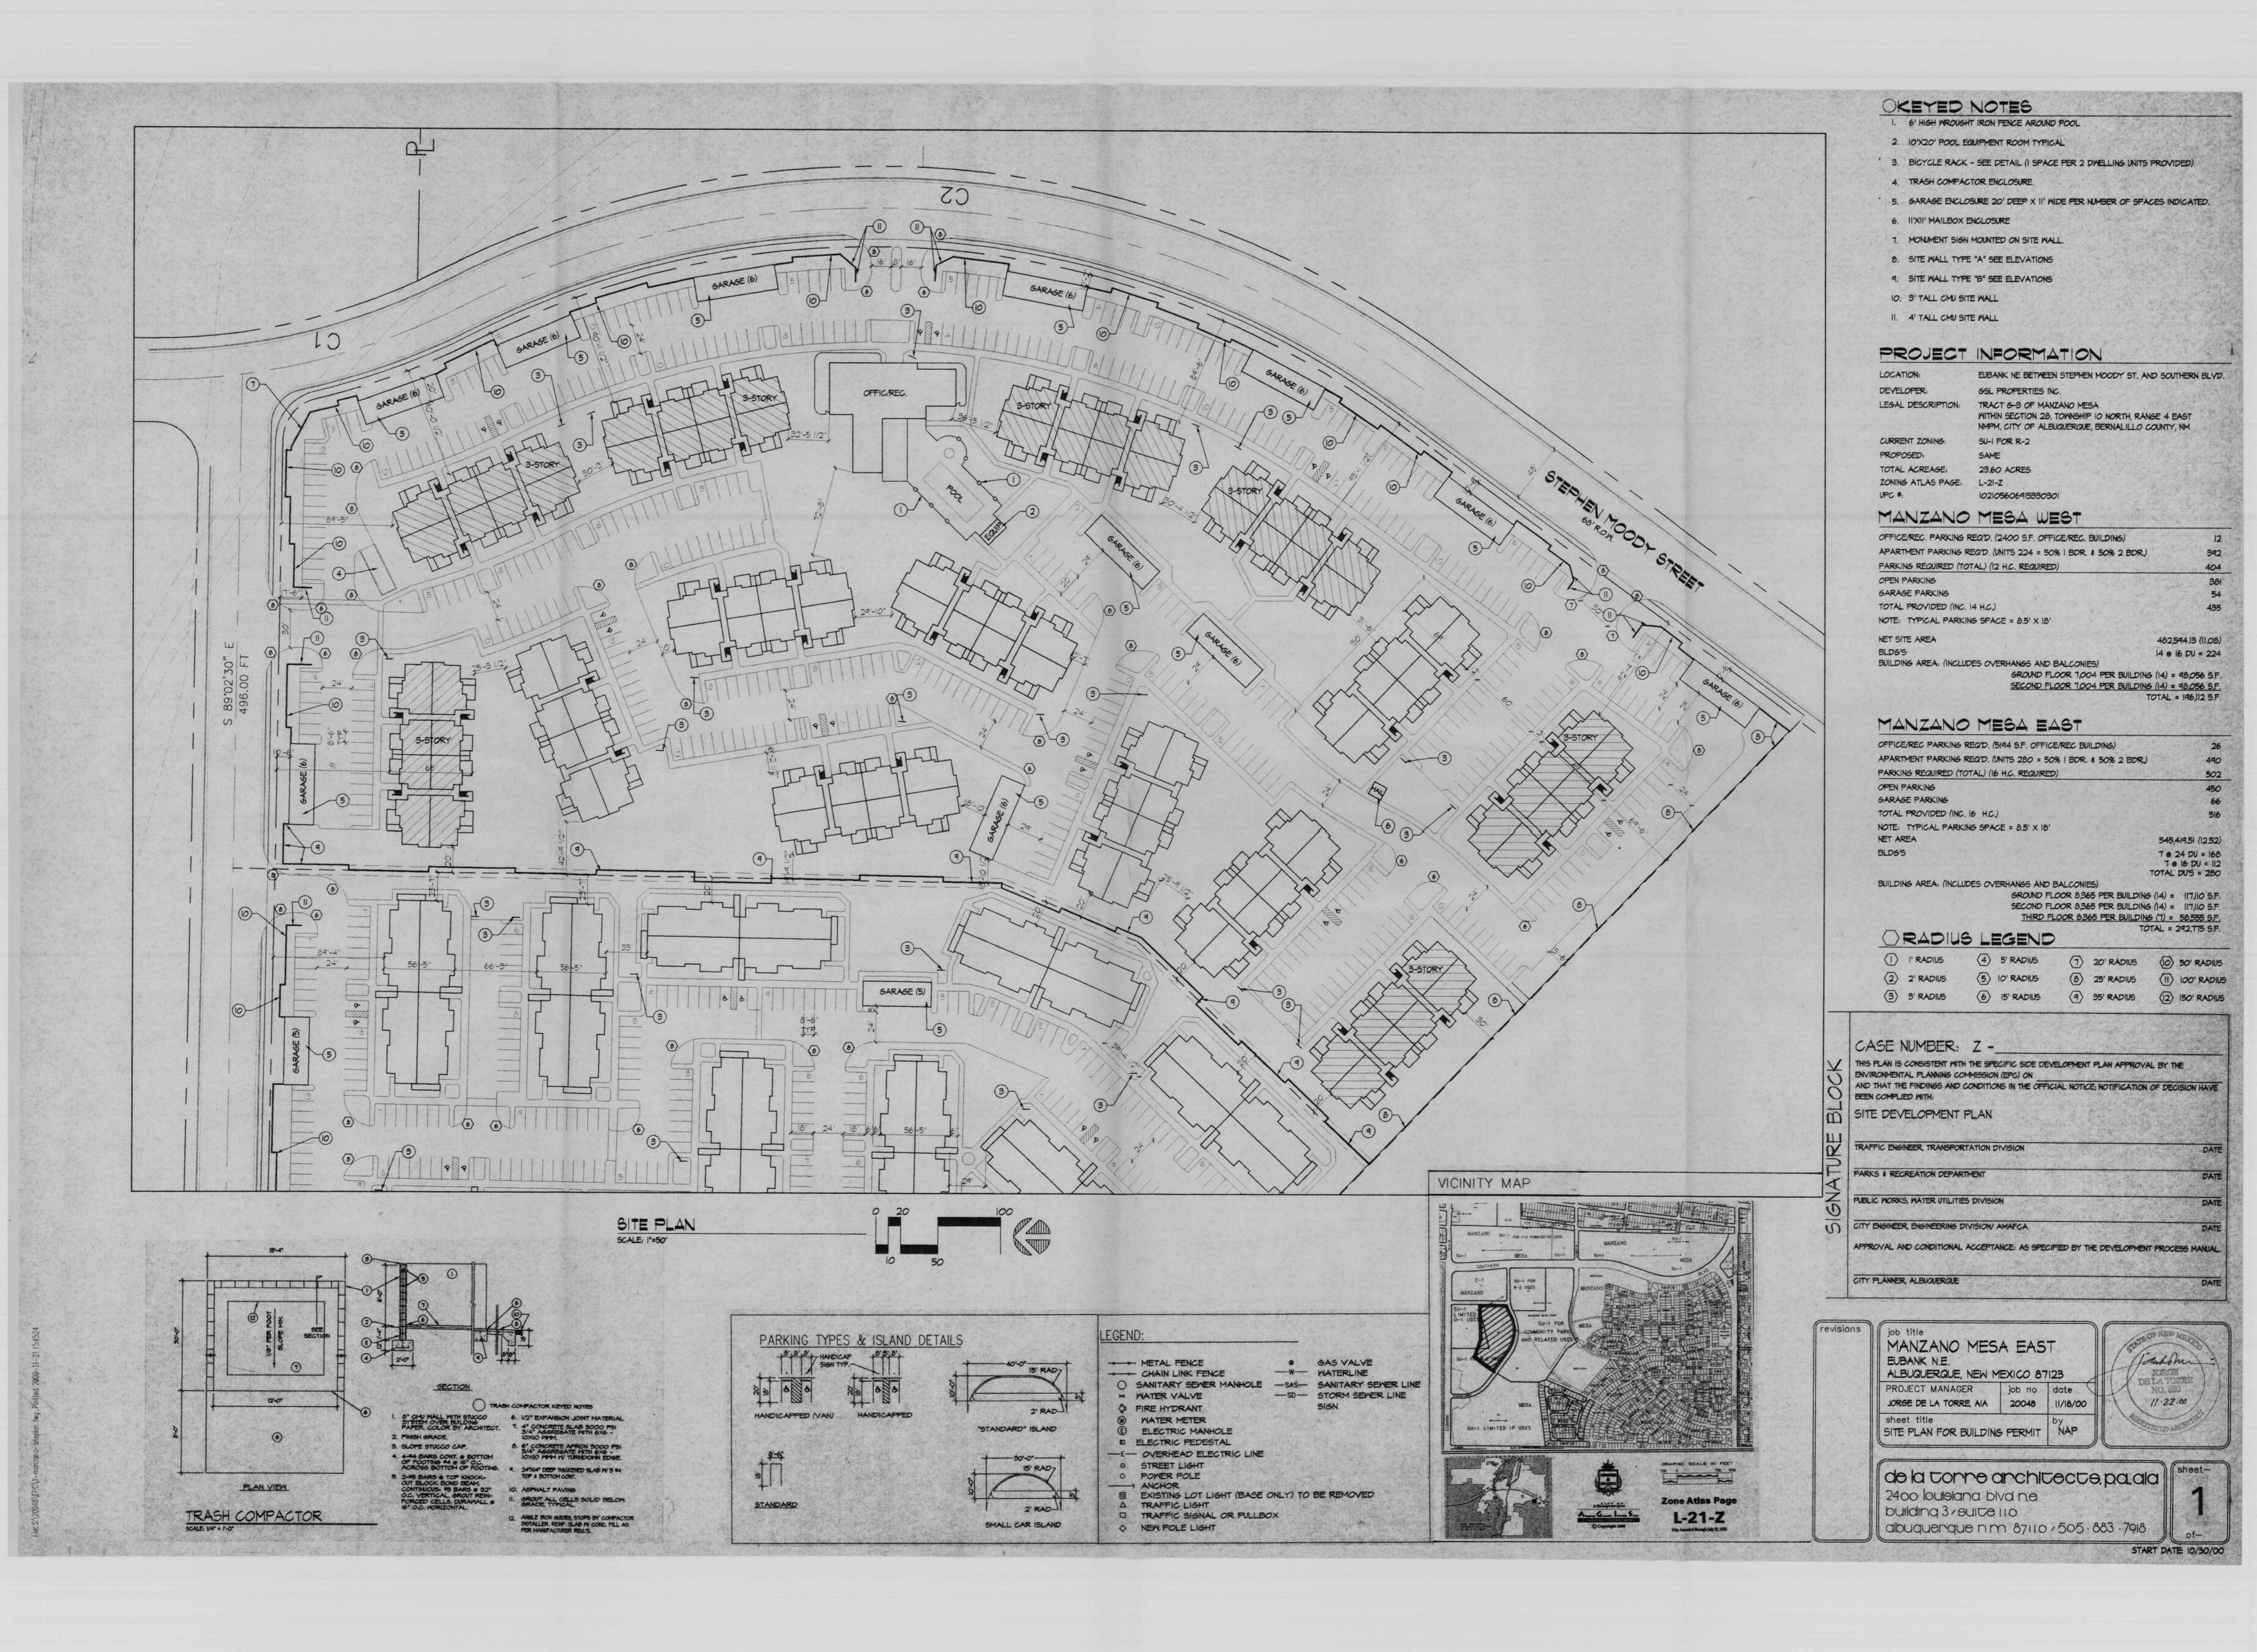


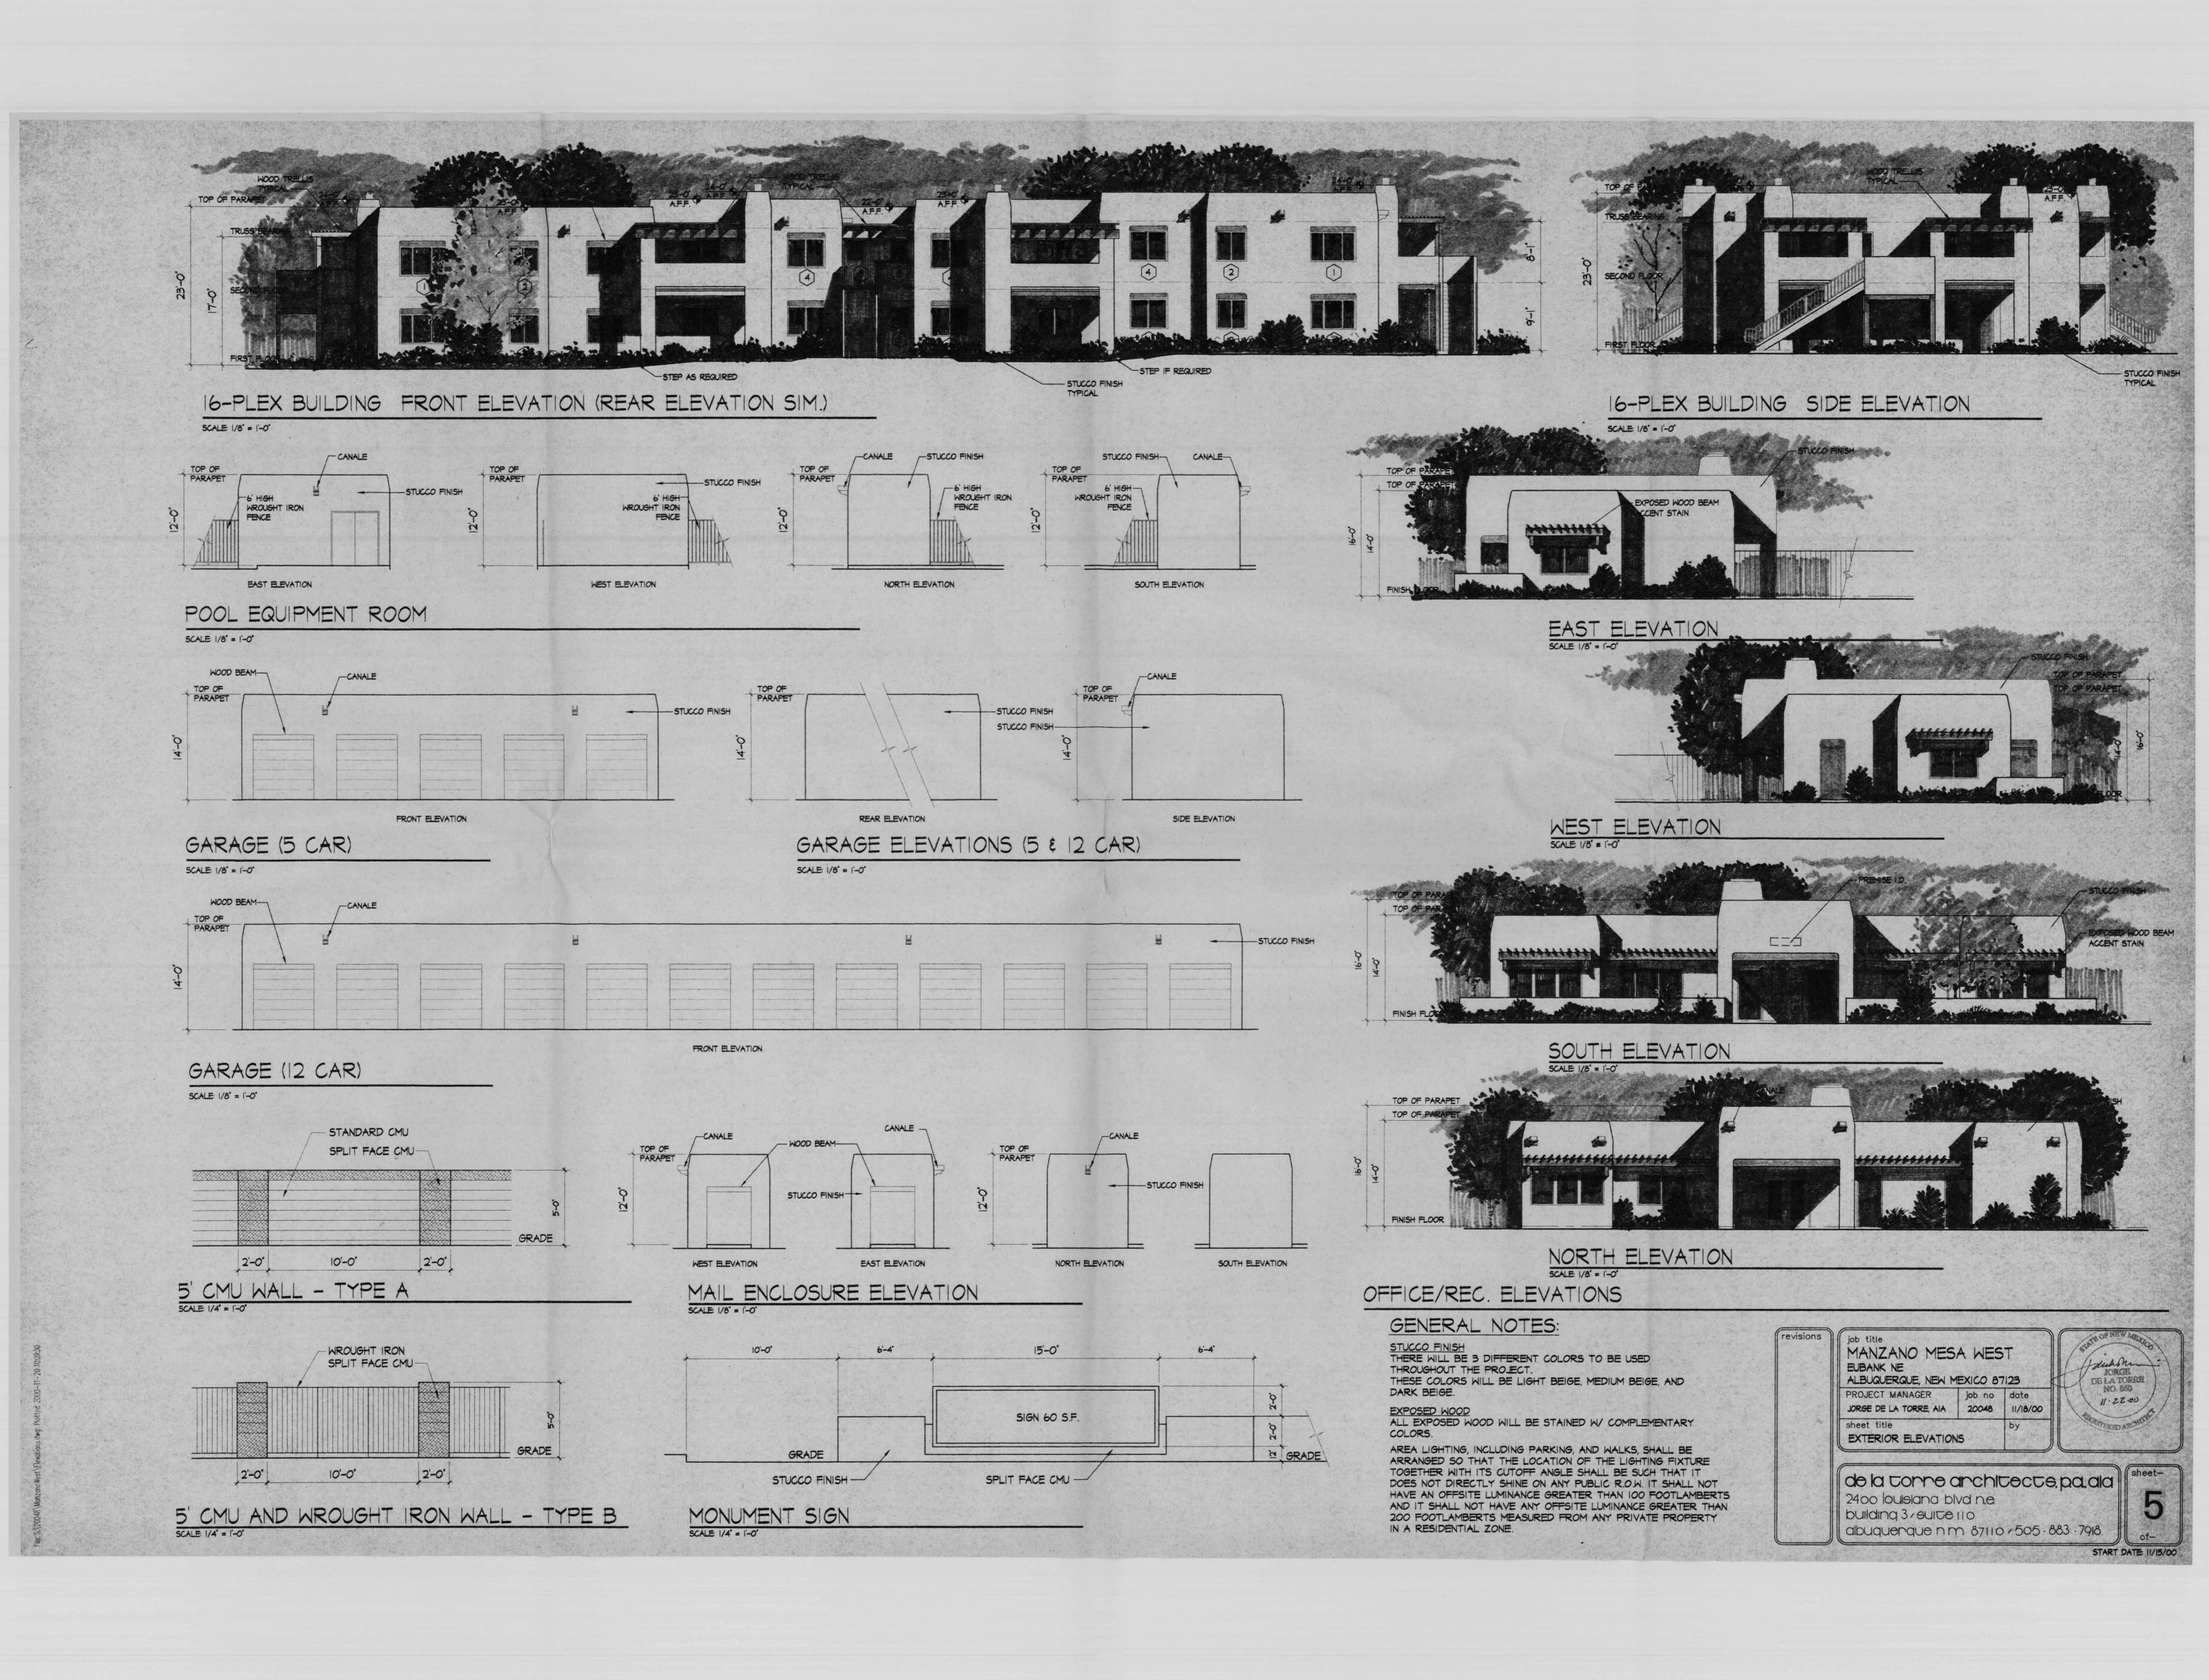



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POOL EQUIPMENT

WEST ELEVATION

SCALE 1/8' = 1'-0'

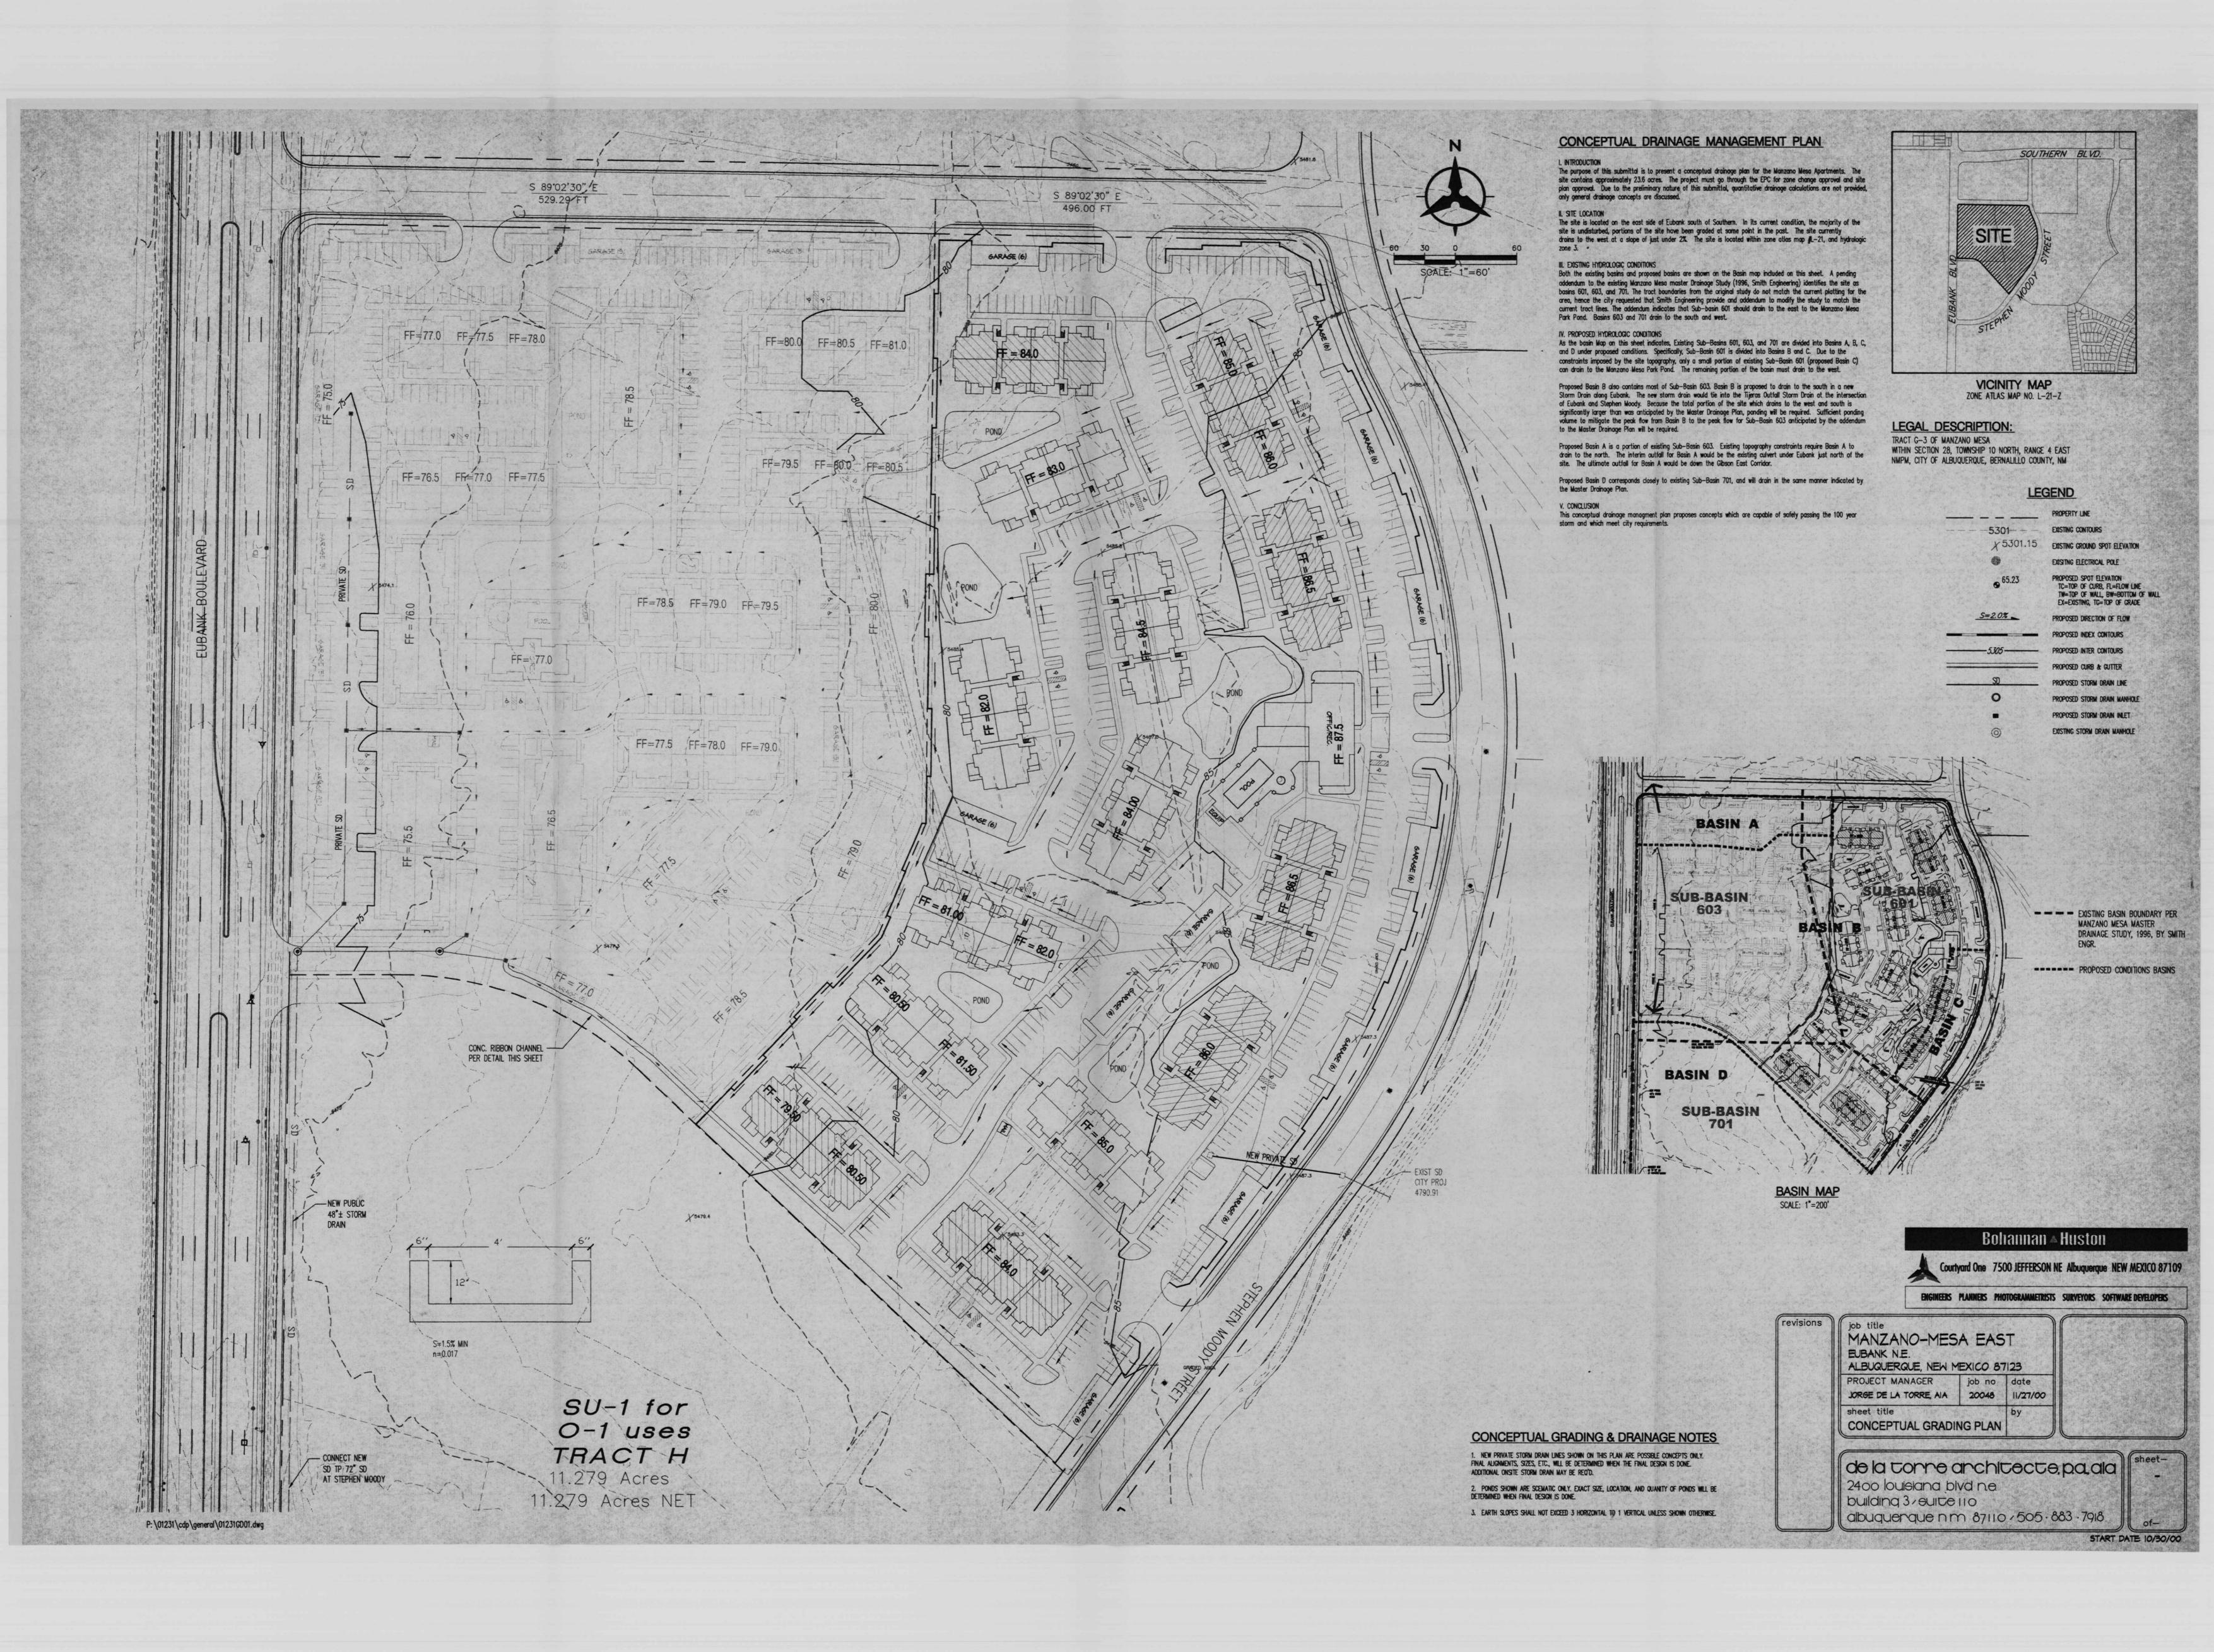POOL EQUIPMENT

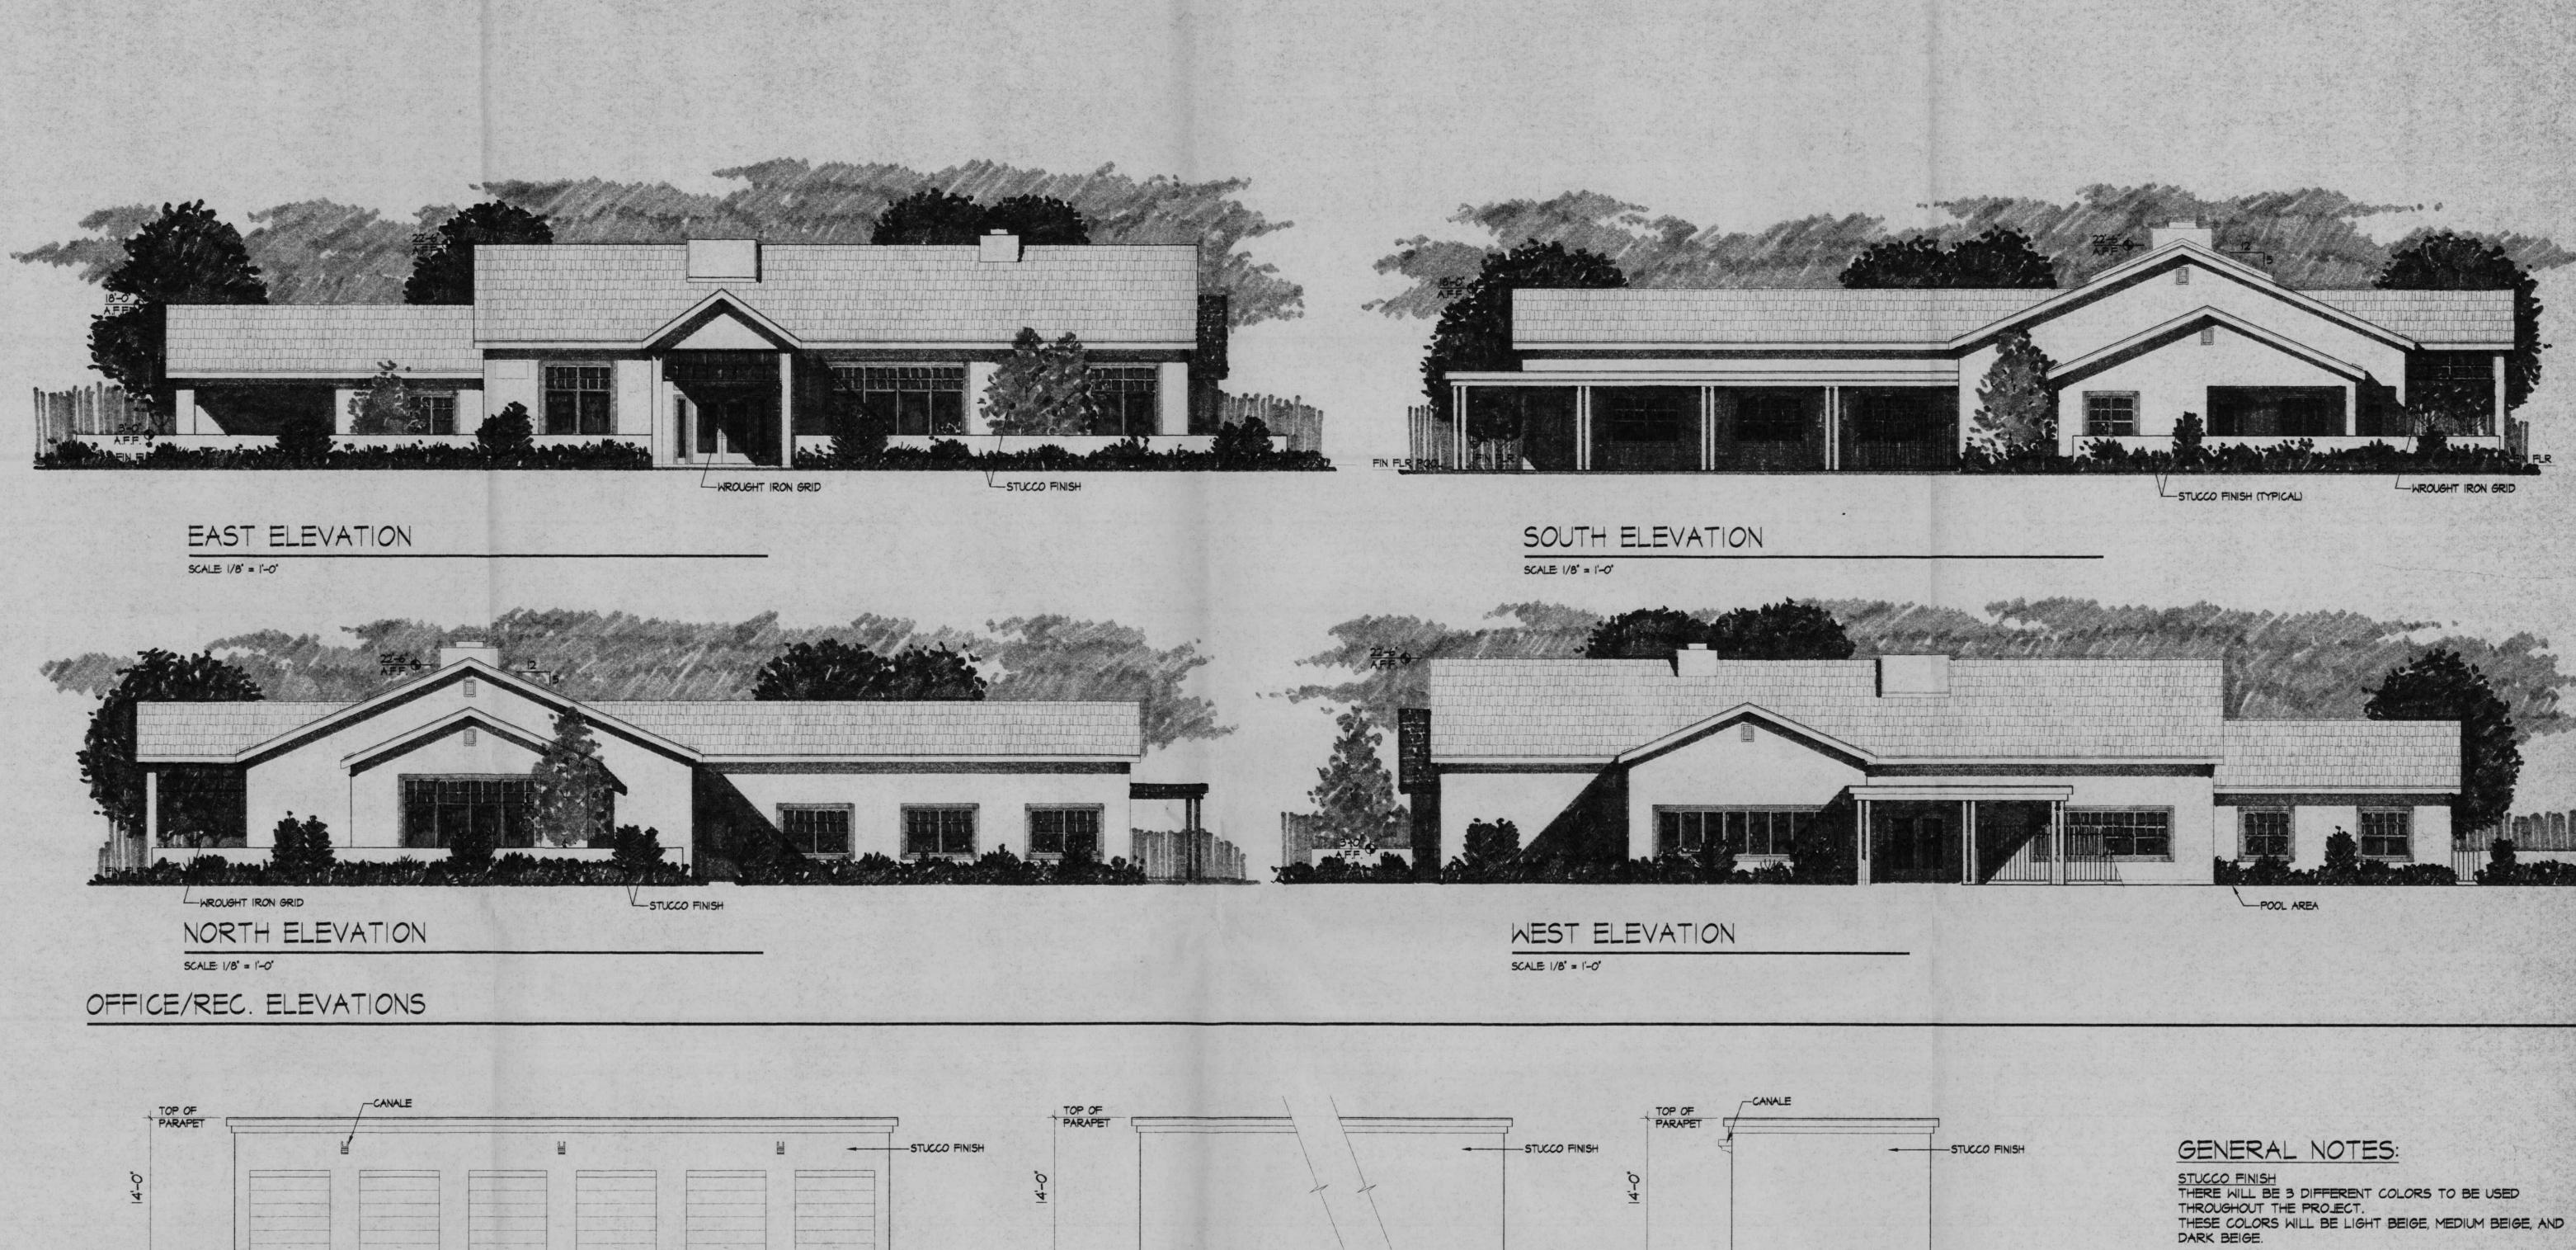SCALE 1/8' = 1'-0"

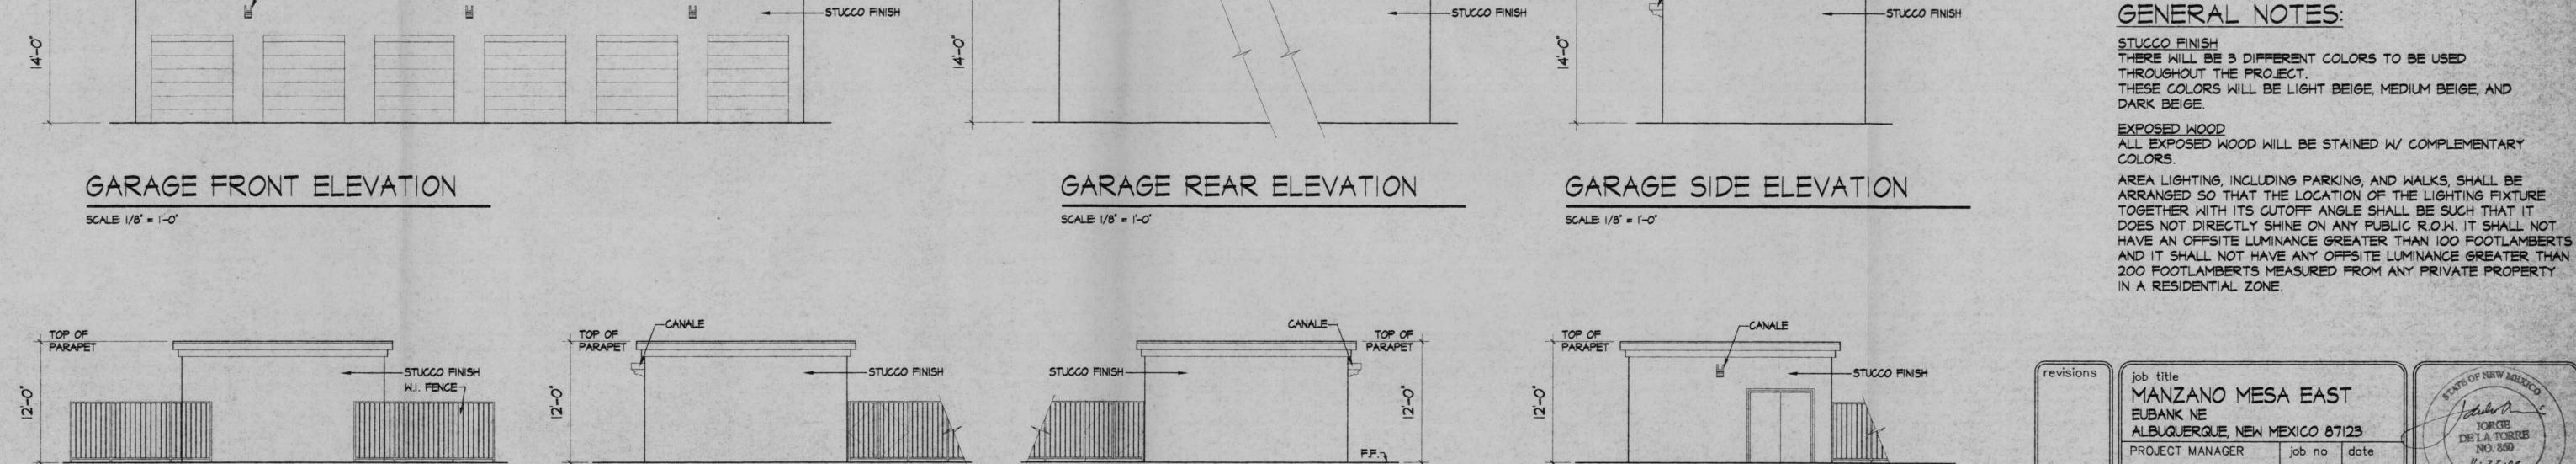SOUTH ELEVATION

POOL EQUIPMENT

EAST ELEVATION

SCALE 1/8' = 1'-0"

POOL EQUIPMENT

SCALE: 1/8' = 1'-0"

NORTH ELEVATION


PROJECT MANAGER NO. 860 11.22.00 JORGE DE LA TORRE, AIA 20048 11/18/00 sheet title de la conne anchitecte, p.a. ala

2400 louisiana blvd n.e.

building 3/suite 110 albuquenque n m 87110/505.883.7918

EUBANK NE


JORGE DELA TORRE

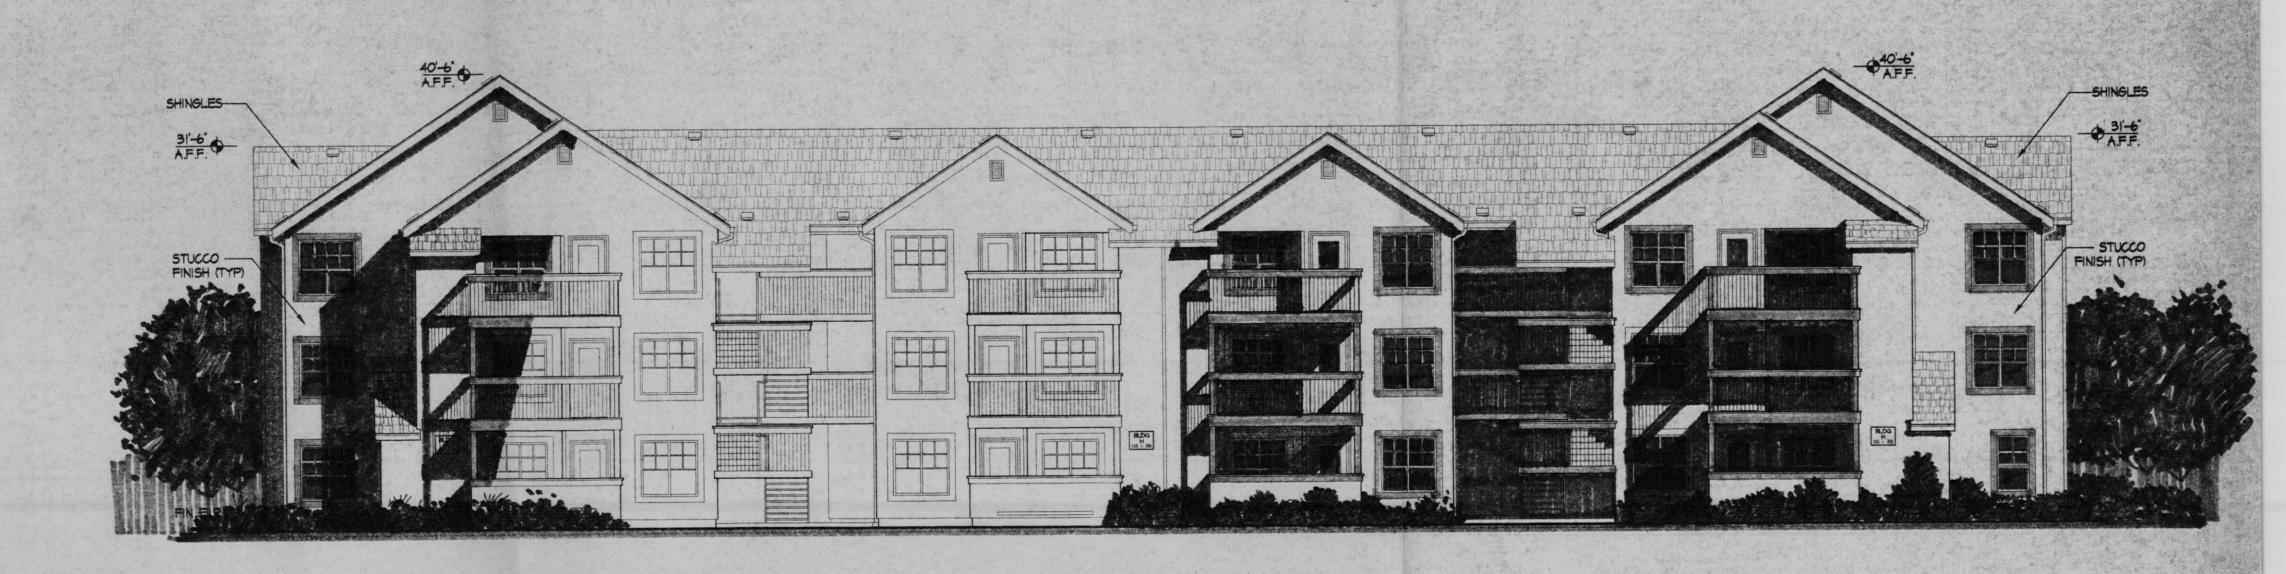

24-PLEX BUILDING - FRONT / REAR ELEVATION

BLDG ALUM. SIGN WITH \_\_\_\_\_\_\_\_ACRYLIC LETTERS MOUNTED ON WOOD TRIM BACK - PAINT TRIM TO MATCH SIDING

BUILDING SIGNAGE

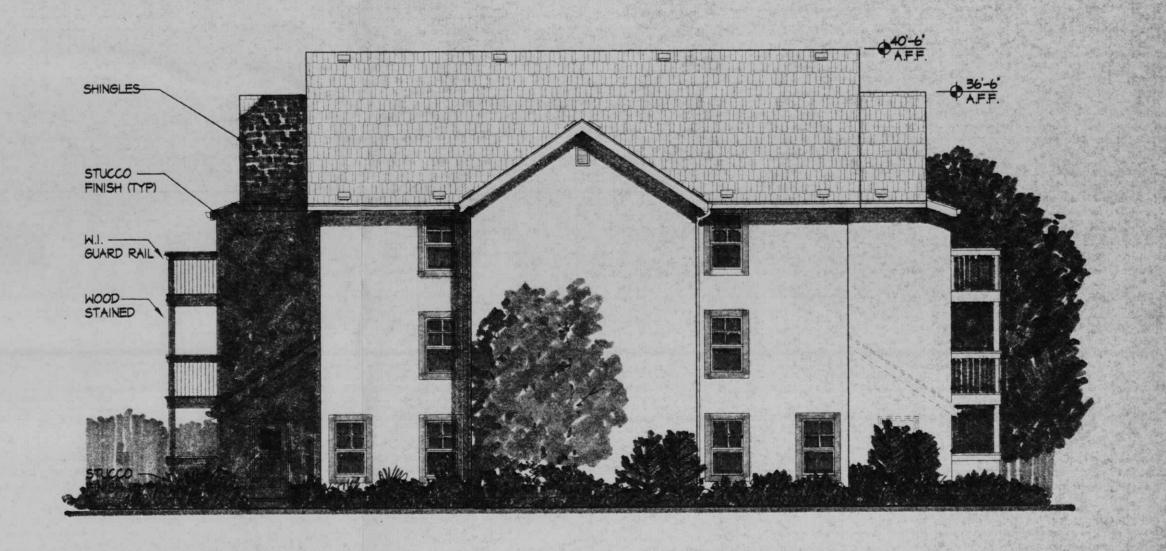


24-PLEX BUILDING - SIDE ELEVATION

MANZANO MESA EAST EUBANK NE ALBUQUERQUE, NEW MEXICO 87123 job no date 20048 11/18/00 JORGE DE LA TORRE, AIA


de la torre architecte, p.a. ala 2400 louisiana biva ne

building 3/suite 110 albuquenque nm 87110/505·883·7918 of— START DATE 11/15/00

16-PLEX BUILDING - FRONT ELEVATION

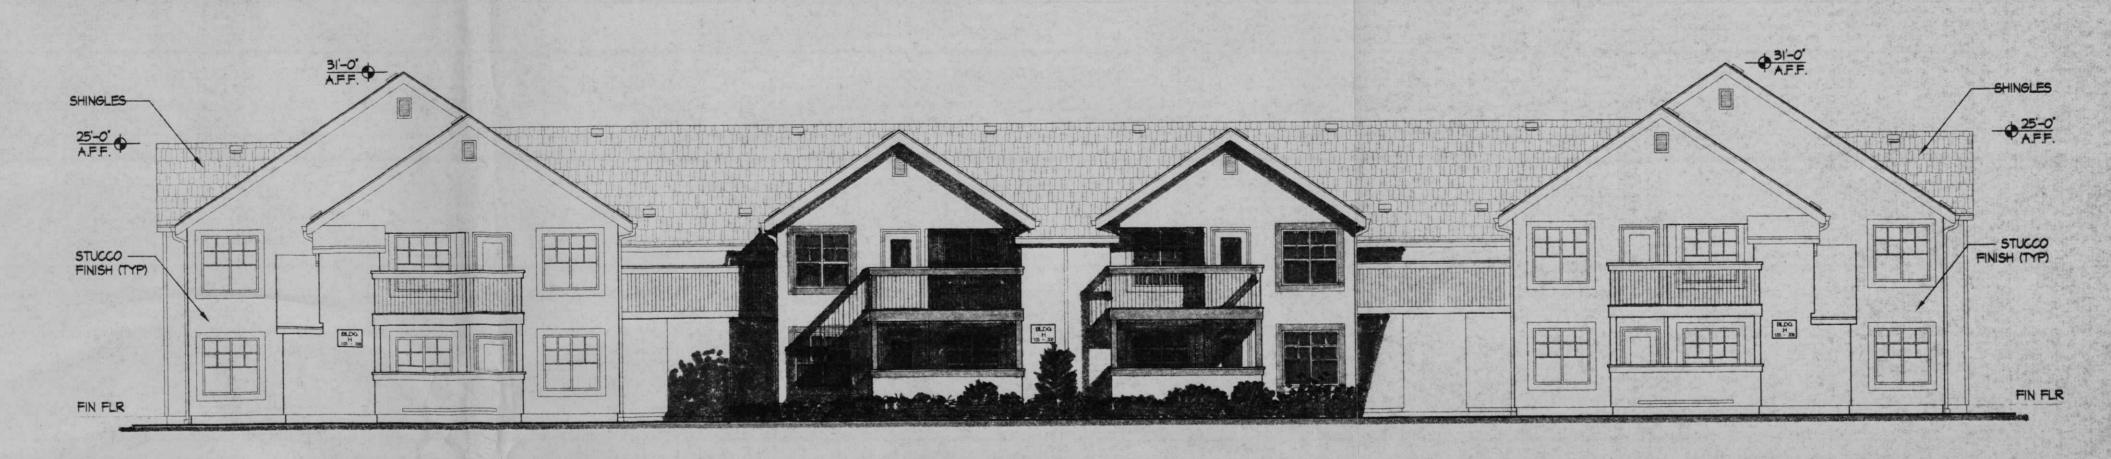

16-PLEX BUILDING - REAR ELEVATION SCALE: 1/8"=1"-0"

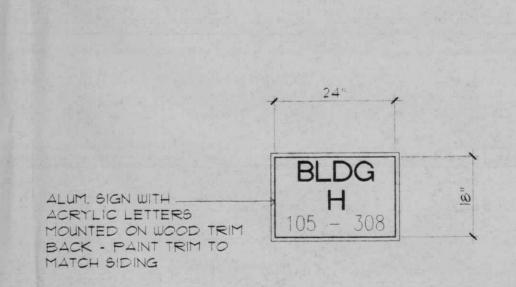

BUILDING SIGNAGE SCALE: NTS



16-PLEX BUILDING - SIDE ELEVATION SCALE: 1/8"=1'-0"

> job title MANZANO MESA EAST JORGE DE LA TORRE NO. 360 11 · 22 · 00 EUBANK NE ALBUQUERQUE, NEW MEXICO 87123 job no date 20048 11/18/00 JORGE DE LA TORRE, AIA

de la tonne anchitecte, pa, ala 2400 louisiana biva ne building 3/suite 110 albuquenque n m 87110/505 883 7918

START DATE 11/15/00